CITY OF SANTA ANA

BUILDING PERMIT WORKSHEET

PLEASE PRINT				1/14/09:form	s/Bldg.App.Worksheet				
PROJECT ADDRESS: SOI	N SAKO	€CN SUITE:		SAPIN#) () [<u> 13394 - </u>				
USE OF BUILDING: RESIDENTIAL COMMERCIAL INDUSTRIAL OTHER 2011-976-13 MASTER ID#									
NATURE OF WORK: NEW AD	DD (ALTER/T.I.) DE	EMO REROOF	REPAIR	SIGN MISC	3				
NEW/ADDITION/ALTERATION:	NEW/ADDITION/ALTERATION:								
1ST FL SF BASEMENT: YES/NOSF NO. OF STORIES:									
2ND FL	(MARKET)	. PATIO:		OG. HEIGHT:					
TOTAL OF OTHER FLS:		EU		OPOSED USE:					
GARAGE/CARPORT: JOB DESCRIPTION (non-resident	OF ALIENIII Hal projects see reverse si	ـــــــــــــــــــــــــــــــــــــ	-31 : Conv	ut theater	r sæstin				
1/ // // Seats		en belvenne e	6 Dey	501-24					
	<i>[</i>	9		<i>J</i> :					
BUILDING OWNER'S NAME:	Market	duce Part	res i	PHONE NO: 역	2921404				
ADDRESS: 100 E W. 19	ion St	CITY: Costa V	1esa !	STATE A	ZIP:				
8	itz and	Yest tac]	PHONE NO:					
CONTRACTOR'S NAME:	::	STATE CONTR. #:		LICENSE CLASS:	PHONE NO:				
ADDRESS:		CITY: STATE:		STATE:	ZIP:				
WORKERS COMP. POLICY#:	EXP. DATE:	INSURANCE COMPA	NY:	SANTA ANA BUS. LIC. #:					
ARCHITECT/ENGINEER:		STATE LICENSE #:		PHONE NO:					
ADDRESS:		CITY:	CITY: STATE: ZIP:		ZIP:				
CONTACT NAME: Denn	5 LW	PHONE N	o: 3/ _{/1} .	-493-20	50				
	, lluy 10,0	Mass 1 co. FAX NO:	714 -	-58 667-6	2174				
OFFICE USE ONLY: (ACC)OR SPC (CIRCLE ONE) 2 HRS PER 1 BLDG. FEE \$									
OCC. GROUP: P/C FEE PD \$ 414,50									
TYPE OF CONSTR: $11/1$ 10 10 VALUATION: \$25,000 SUBMITTAL DATE: $10-10-11$									
FIRE SPKR: YES / NO A/C: YES	/NO FLOOD ZONE:_	<u> </u>	F	PROCESSED	<u> </u>				
RES. DEV. FEE: YES / NO PRIOR	R DWELLING UNIT: YES/	NO COMMENTS:	••••						
PLANNING OK TO CHECK & DATE-		BLDG. DEPT. APF	PROVAL & D	ATE	anna de la composición del composición de la com				

PLNG CONDITIONS:

CITY OF SANTA ANA PLAN CHECK - CHECKLIST

	PLAN	CHECK - CH	IECNLI3	::	
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4.	I understand that I shall so following when plan check		ans, applica	itions and plancheck	fees for the
6	a. Electrical Plans - 2 cob. Plumbing Plans - 3 co			nical Plans - 2 complet g Plans - 3 complete so	
<u></u> 5.	I understand that I shall inspection of the property permit I am required to obt \$30,000 or has added plur	is required. I unde ain Public Works /	erstand that p Agency appr	orior to the issuance of oval if my project valuat	the Building tion exceeds
AGREED TO B	Y APPLICANT OR AGENT				
Applicant's Sign	ature/22/2				energy of the second se
Print Name	Dennis Lly	Addres	s_26\s_	N. Sprige	<u> </u>
Telephone Nun	ber <i>31/6= 493=3</i> 2	Σ <u>/</u> F:	3x <u>7/4</u>	6670174	andiganistro-recording the specific section of the
FOR OFFICE U	SE ONLY: "Checklist of i	tems discussed"	APPROVA	LS & FEES REQUIRE	D: Y/N
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		FEE CHECKLIST	T WORKSHEE	12 :::	
Received by	y:		SAPIN#:	101733	<u>94</u>
3 2 2		FEE TYPE	REQUIRED Yes No		
e ac	*	Plan Check Fee Disability Fee SMIP Fee			0 % 03 %
* :: * :: : : : : ::	# ### ################################	Res. Dev. Fee Fire Facility Fee School Distr. Fee Microfilm FCWP Surcharge		* * *	e Y
		CALCULATI	ON AREA		:
w. B	COST/SQ FT	X TOTAL	SQFT =	VALUATION	
		contrac	4		

Counter computations/valuation \$__25_000_____

Plan checker computation/final valuation \$_____



Planning and Building Agency Planning Division 20 Civic Center Plaza P.O. Box 1988 (M-20) Santa Ana, CA 92702 (714) 647-5804 www.santa-ana.org

Sapin Dev Rev **Application Data Sheet**

Master I.D.: 2011-97643

Application Number: NONR-2011-562-ALT

Project Address: 307 N Spurgeon St

Application Date: 10/10/2011

Planner/Project Manager: Soboleske, Hally

Determination:

Approved

Application Description:

Alter mezzanine seating from theater seating to box seating.

Dev Rev Project Conditions:



Planning & Building Agency Permits & Plan Check Section 20 Civic Center Plaza P.O. Box 1988 (M-19) Santa Ana, CA 92702 (714) 647-5800 www.santa-ana.org

ACCELERATED PLAN CHECK REQUEST

	- A	ييسي	promise in the second second	HO18: 07-01-11
Project Address: <u>SC</u>		Saucē	te ogg	Owner, et al.
Misc. Receipt: 582	<u> 258</u>	Processed By:	Plan Ch	necked By:
Cost: \$117.70 per hou fee is in addition			hecker will estimate the	number of hours for review. This
Type of Plan Check:	Building <u>)</u>)1 <i>773</i> 59'	Electrical	
	Est. Hrs.	2 Actual <	24 Est. Hrs.	Actual
	Plumbing) Mechanic	al
	Est. Hrs.	Actual	Est. Hrs.	Actual
Owner/Representative Sig	gnature:	<u> </u>		
Print Name: Des	MS LL			Date: 10 - 10 1
Telephone Number: (3/()) 44%-2	<u> 150 </u>	Fax Number: ()	
(1) n				
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	•		include the following:	
Fire, Police,	Public Works,	Planning or Lan	ndscaping Plan Check	
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tribution: White: Office prete/Fee Schedules/2011-2012

Yellow: Applicant



Planning & Building Agency Building Safety Division 20 Civic Center Plaza P.O. Box 1988 (M-19) Santa Ana, CA 92702 (714) 647-5800 www.santa-ana.org

TENANT IMPROVEMENT PLAN CHECK COMMENTS

PLAN CHECK NO:		10173394					
PROJECT ADDRESS:		307 N Spurgeon St					
PLAN CHECK ENGINE	ER:	Mazarji, Z	ac	TEL:	714	647-5831	
				FAX:	714	647-5897	
TYPE OF CONSTRUCT	ION:		III B, SPK				
OCCUPANCY CLASSIF	FICAT	ION(S):	A-2		***********	••••••	
PLAN CHECK DATES: APPLICATION	10/10	/2011		REM	ARKS/	RECHECK ITEMS:	
INITIAL REVIEW	10/11	/2011		-20000000000000000000000000000000000000			
EXPIRATION	4/7/2	012					
RECHECKS: 1.				אחא	IEAT /	יייי'.ICANT CONTACT PERSON:	
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VALUATION: \$25,000	0,00		of 11 Nec	عل		is.lluy@gmail.com	
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APPLICA	ABLE	٠			,	CBC) WITH	
		li	c notified	_ Den	(re/)		
All items noted on to your project, note		ar				nat an item is not applicable	

- Please indicate the sheet number and detail to the right of each correction, or note the number on the
 plans where the correction is made. <u>Resubmit marked original</u>, calculations and this correction sheet. A
 separate sheet for response may be used.
- 3. Resubmit 4 corrected sets of plans.
- 4. Meetings between the project applicant/designer and the plan reviewer shall be by appointment only. Please call (714) 647-5831 for an appointment.
- 5. Please return marked up set of drawings with corrections.

- CBC Sections A106.1 and A106.3.4.1, All drawings and supporting documents shall be prepared, stamped and signed by a California licensed architect or registered civil engineer. <u>Architectural drawings</u> to be signed by licensed architect.
- 7. This review does not include mechanical, plumbing, fire sprinkler system, or electrical work. Separate plans, applications, fees, plan checks, and permits are required for mechanical, plumbing, fire sprinkler systems, and electrical work. Call 647-5800 for information.
- 8. The applicant shall obtain clearances/approvals for the following prior to building permit issuance:
 - Planning Division approval on the corrected/final set of drawings (647-5804.) Previously approved plans should be submitted to expedite the process.
 - Fire Department approval on the corrected/final sets of drawings (647-5839 or 647-5700)
 - Police Department approval on the corrected/final set of drawings (647-5840)
 - Public Works Agency approval (647-5039)
 - County of Orange Health Department approval on the corrected/final set of drawings (667-3600)
 - Proof of Worker's Compensation Insurance shall be required at the time of permit issuance
- Fire blocking. In combustible construction, fire blocking shall be installed to cut off concealed draft openings (both vertical and horizontal) and shall form an effective barrier between floors, between a top story and a roof or attic space. Fire blocking shall be installed in the locations specified in CBC Sections 717.2.2 through 717.2.7.
- 10. Provide handrail details on the drawings showing compliance with CBC Section 1009.10, 1012, and 1133B.4.1. Please note new dining area requires handrails on both sides. Please see attached handout and revise drawings to show compliance.
 - Stairways shall have handrails on each side.
 - Handrails shall be 34 to 38" above the nosing of treads.
 - Handrails shall extend a minimum of 12" beyond the top nosing, and shall extend a minimum of 12" plus the tread width beyond the bottom nosing.
 - The handgrip potion of handralls shall not be less than 1½" nor more than 1½" cross-sectional dimension or the shape shall provide an equivalent gripping surface. The handgrip portion of handralls shall have a smooth surface with no sharp corners. Any wall or other surface adjacent to the handrall shall be free of sharp or abrasive elements. Edges shall have a minimum radius of 1/8".
- 11. CBC Section 1133B.4.2.2. Handrails shall extend a minimum of 12" beyond the top nosing and 12", plus the tread width, beyond the bottom nosing. At the top, the extension shall be parallel with the floor or ground surface. At the bottom, the handrail shall continue to slope for a distance of one tread width from the bottom riser; the remainder of the extension shall be horizontal. See Figures 11B-35 and 11B-37.
- 12. CBC Section 1013.2. The top of the guards shall not be less than 42" in height.
- 13. CBC Section 1013.3. Open guards shall have intermediate rails or an ornamental pattern such that a sphere 4" in diameter cannot pass through.

- 14. Please clarify location of landing from each side of new dining area when used as exit way.
- 15. Refer to the attached Accessibility hardship form and complete to show compliance with Section 1120 B.1.2 of CBC for proposed dining room on the mezzanine level. (No elevator to mezzanine level).



Planning & Building Agency **Building Safety Division** 20 Civic Center Plaza P.O. Box 1988 (M-19) Santa Ana, CA 92702 (714) 647-5800 www.santa-ana.org

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PLAN CHECK NO:			10173394					
PROJECT ADD		•	307 N Spurgeon St					
PLAN CHECK			Mazarji, I	Zac	TEL:	714	647-5831	
The same of the sa					FAX:	714	647-5897	
TYPE OF CON	STRUC	TION:		III B, SPK				
OCCUPANCY			ION(S):	A-2				
PLAN CHECK					REM	ARKS	/RECHECK ITEMS:	
APPLICATION		10/10)/2011					
INITIAL REVIE	W	10/11	/2011					
EXPIRATION		4/7/2	012					
RECHECKS:	1.		٠.		PRO	JECT	APPLICANT CONTACT PERSON:	
- 	2.				Dennis Lluy			
E STATE OF THE STA	3.		***************************************		TEL:		(310)493-2050	
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VALUATION:	\$25,0	00.00			EMA	IL:	dennis.lluy@gmail.com	
FLOOD ZONE:	X-060)23202′	76J			,,,,,,,,,,,,,,,,,,,,,,,,,,,,,,,,,,,,		

APPLICABLE CODE: 2010CALIFORNIA BUILDING CODE (CBC) WITH CITY OF SANTA ANA AMENDMENTS

- 1. All items noted on this plan check report must be addressed. If you feel that an item is not applicable to the state of to your project, note "N/A" and discuss the reason with the plan checker.
- 2. Please indicate the sheet number and detail to the right of each correction, or note the number on the plans where the correction is made. Resubmit marked original, calculations and this correction sheet. A separate sheet for response may be used.
- 3. Resubmit 4 corrected sets of plans.
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- 5. Please return marked up set of drawings with corrections.



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CBC Section 1013.2. The top of the guards shall not be less than 42" in height.

CBC Section 1013.3. Open guards shall have intermediate rails or an ornamental pattern such that a sphere 4" in diameter cannot pass through.

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LAWSON-BURKE STRUCTURAL ENGINEERS, LLC 312 OCEAN AVENUE, LAGUNA BEACH, CA 92651 (949) 494-0776

STRUCTURAL CALCULATIONS FOR

Yost Theater Box Seating

JOB ADDRESS: 307 N. Spurgeon St. Santa Ana, CA 92701


JOB #: 21147 BS

PROJECT ENGINEER: TJB

CLIENT: Dennis Lluy

RECEIVED

OCT 10 2011 City of Santa Ana

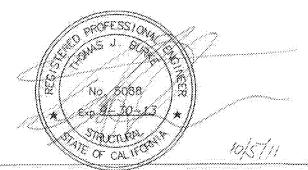

THOMAS J. BURKE, S.E.

DATE

W10000 1

William Ac

CITY OF

		LAW	SON-E	BURKE	
STRI	JCTU	RALENG	INEER	S, LLC	
·		312	OCEAN	AVENUE	
		LAGUNA	BEACH,	CA 92651	
			(949)	494-0776	

Yost Theater Box Seating

307 N. Spurgeon St. Santa Ana, CA 92701

Sheet No. ____/ __of__ Job No. 21147BS By <u>130</u> Date 10/9(1)

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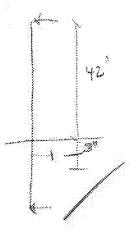
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1.6 Mu= 480 St- #

79 +1/2 BAR OM 0= 0.9 (0.75)(15) (36,000)/2= 1140 +7+ 0L

VERTICALS



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Mu= 300 (45) = 13500 in-d

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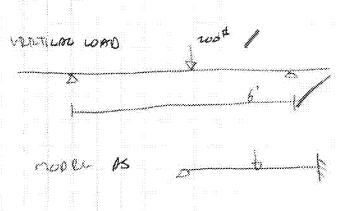
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			312 OCEAN AVENU	JΕ
			LAGUNA BEACH, CA 926	
			(949) 494-07	76

Yost Theater Box Seating 307 N. Spurgeon St. Santa Ana, CA 92701


Sheet No. 2 of Of Job No. 21147BS



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	LAW	SON-E	BURKE	
STRUCTU	PALENG	INEER	S,LLC	
	312	OCEAN	AVENUE	
	LAGUNA	BEACH,	CA 92651	
		(949)	494-0776	

Yost Theater Box Seating 307 N. Spurgeon St. Santa Ana, CA 92701 ETALK-NEW B FRANK

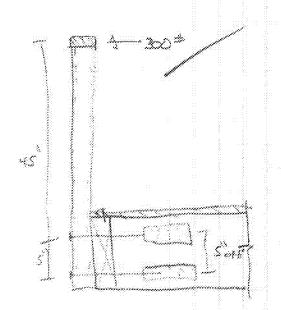

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APPROVED PLANNING DIVISION


MASTER LD 2011-99643 OP DC TRANSFERRED BY. PLANNING INSPEC ROUGH.

RETAIN PLANS FOR PUTURE REVISIONS. SUBJECT TO ITEMS DISCUSS AND CONDITIONS BELOW:

- Q METOT V GAR
- Q NOTESTED A TELEVISIONS
- Q 78. STEPRESTING

CONDITIONS

APPROVED

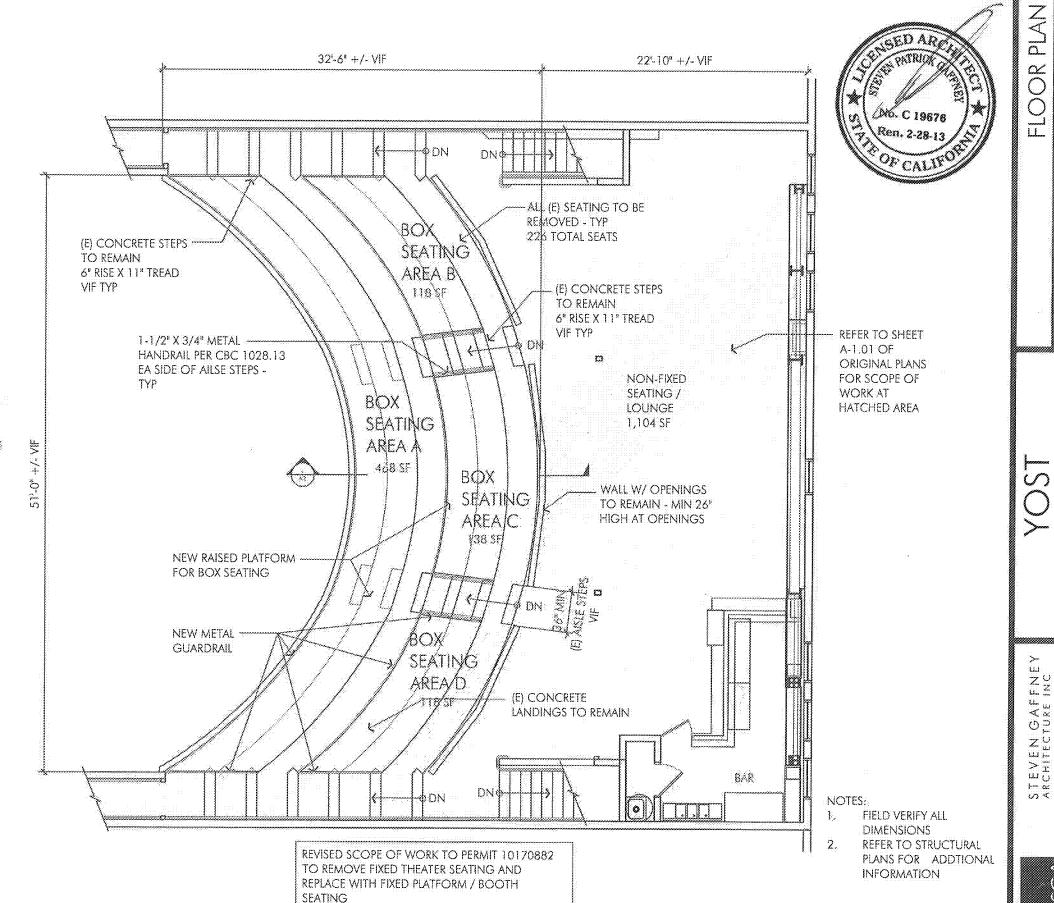

10-3-11

DATE

EATER Spurgeon Street Ante, California


드건 및 등

305 WEST FOURTH STREET SANTA ANA CA 92701 www.SGaffneyArch.com

TEL. 714.571.0500 FAX: 714.571.0600

06-017

JOB NO.

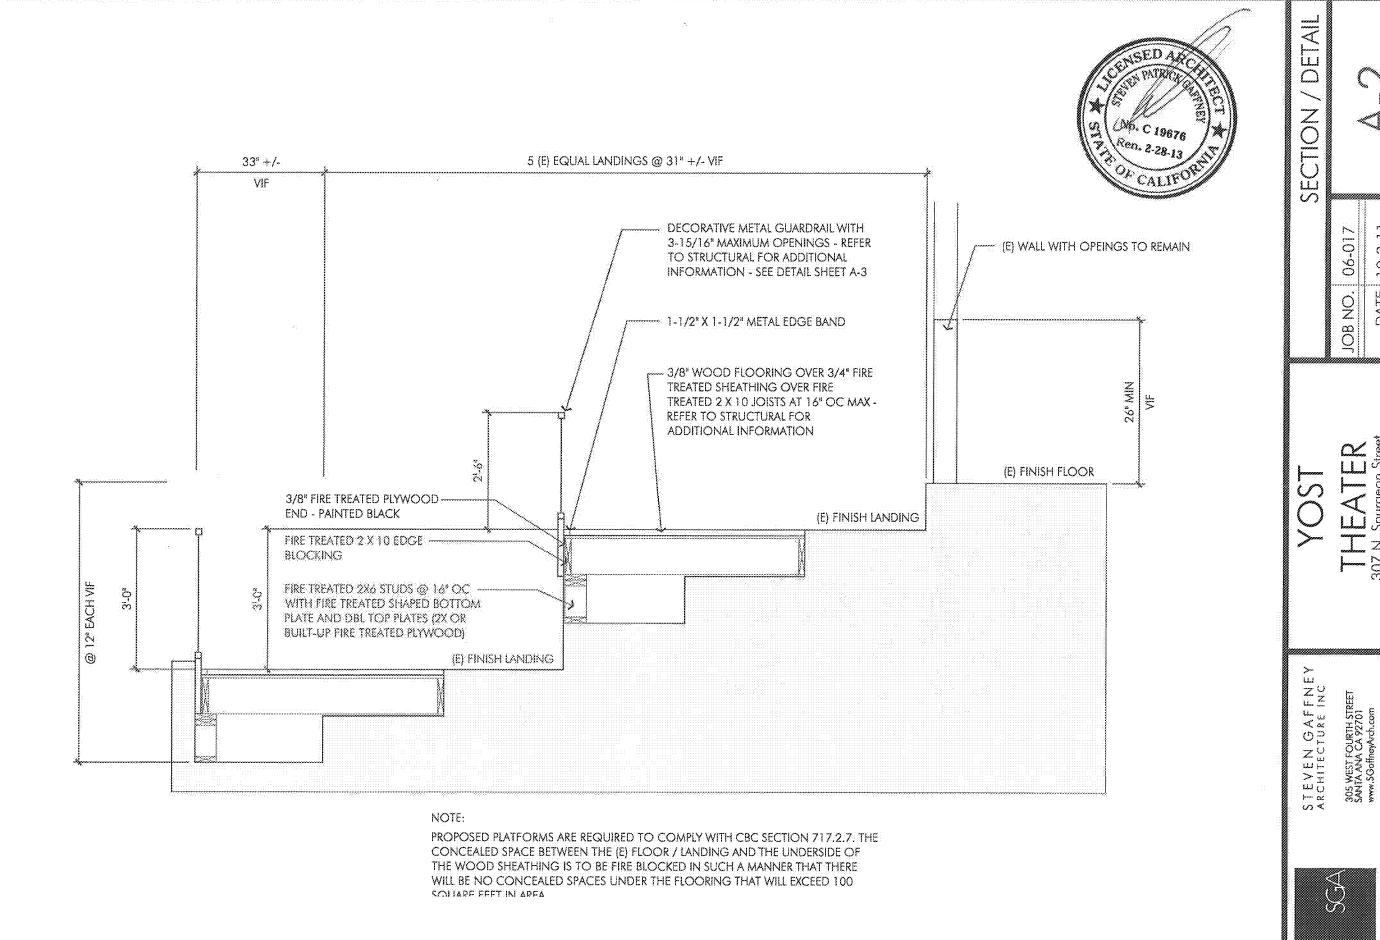


10-3-11

DATE

TEL 714.571.0500 FAX: 714.571.0600



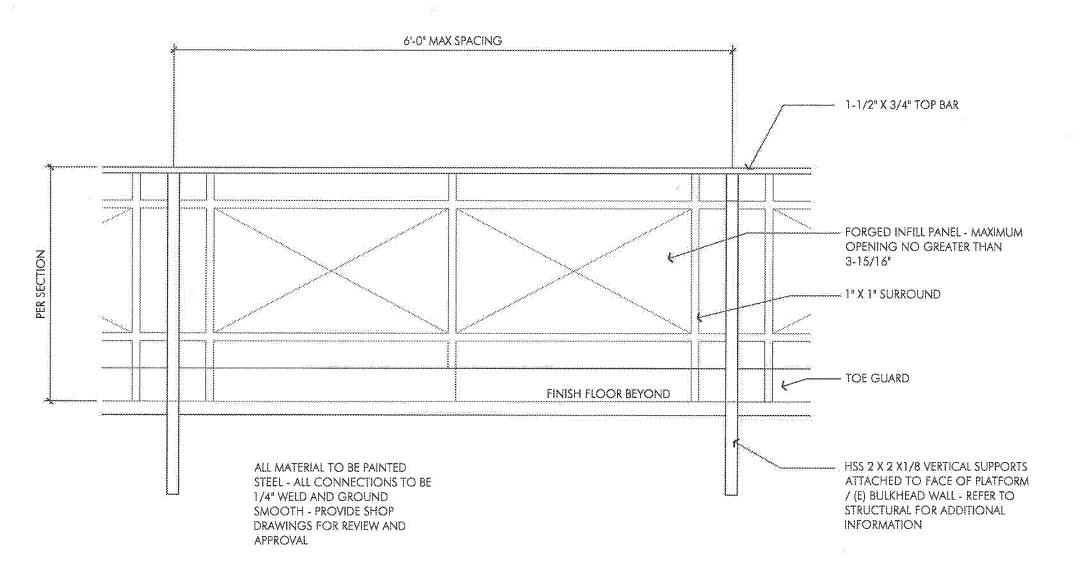

RAIL DETAIL

THEATER 307 N. Spurgeon Street Santa Ana, California 92701

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11 1 0 11 Y C 11

10-3-11

DATE


06-017


JOB NO.

305 WEST FOURTH STREET SANTA ANA CA 92701 www.SCoffneyArch.com

TEL. 714.571.0500 FAX: 714.571.0600

STEVEN GAFFNEY

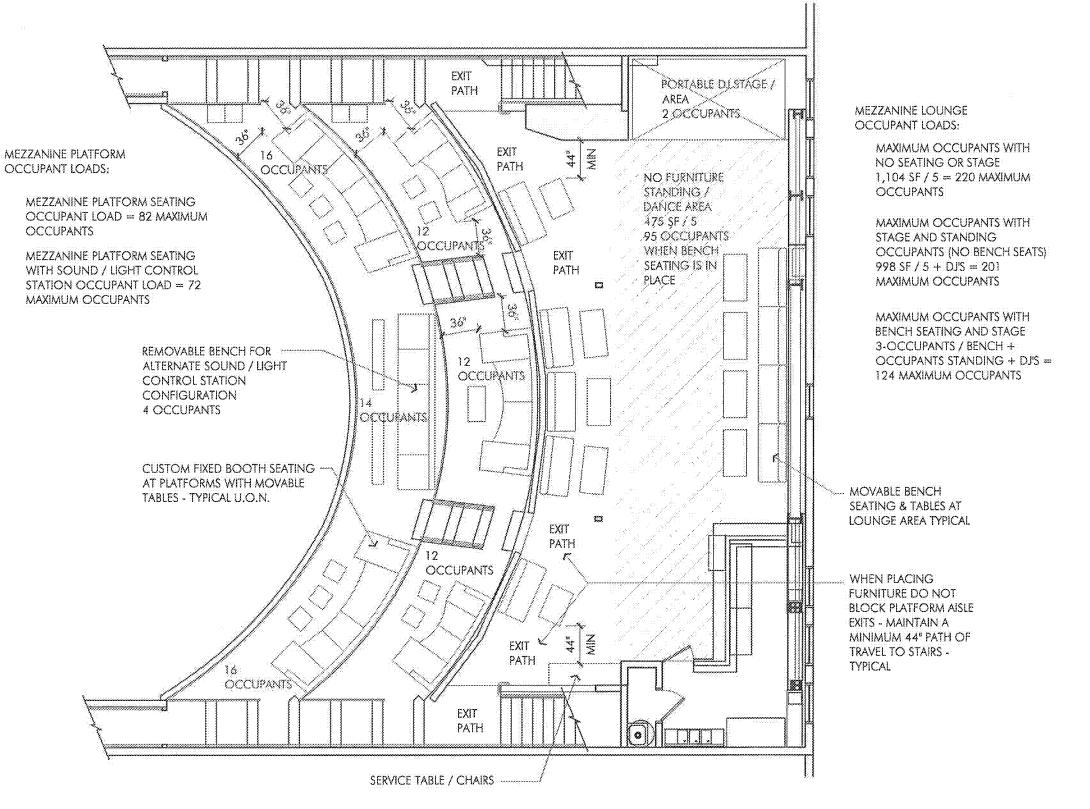

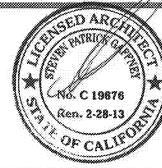

POSTED MEZZANINE MAXIMUM OCCUPANT LOADS:

> NO SEATING OR STAGE AT IOUNGE, NO SOUND / LIGHTING AT PLATFORMS = 302 MAXIMUM

NO SEATING OR STAGE AT IOUNGE, WITH SOUND / LIGHTING AT PLATFORMS = 292 MAXIMUM OCCUPANTS

IOUNGE, NO SOUND / LIGHTING AT PLATFORMS = 283 MAXIMUM **OCCUPANTS**

IOUNGE, WITH SOUND / LIGHTING AT PLATFORMS = 273 MAXIMUM OCCUPANTS

SEATING WITH STAGE AT IOUNGE, NO SOUND / LIGHTING AT PLATFORMS = 206 MAXIMUM **OCCUPANTS**

SEATING WITH STAGE AT IOUNGE, WITH SOUND / LIGHTING AT PLATFORMS = 196 MAXIMUM **OCCUPANTS**

OCCUPANTS

NO SEATING WITH STAGE AT

NO SEATING WITH STAGE AT

CUPANCY 10-3-11 06-017 FURNIUR DATE JOB NO.

SCALE

PAN NAN

LATER

1. Spurgeon Street
1 Ana, California
92701 307 Z. Santa /

305 WEST FOLIRTH STREET SANTA ANA CA 92701 www.5GaffneyArch.com

STEVEN GAFFNEY

714.571.0500 EX.

....



GEN TRAL STRUCTURAL NOTES:

- Coordination: The Contractor shall verify all dimensions and conditions at the job site and shall be responsible for coordination of all work and materials including those furnished by subcontractors.
- 2. Discrepancies: The Contractor shall inform the Engineer in writing, of any discrepancies or omissions noted on the drawings that do not conform to codes, rules and regulations. Upon receipt of such information, the Engineer will send written instructions to all concerned. Any such discrepancy, omission, or variation not reported shall be the responsibility of the contractor.
- 3. Typical Details and Notes on these sheets shall apply unless specifically shown or noted otherwise. Construction details not fully shown or noted shall be similar to details shown for similar conditions. All construction work shall comply with all applicable building codes, regulations and safety requirements.
- 4. Trade Names: Where an item is identified by a trade name the suffix "or approved equivalent" shall be implied unless specifically noted otherwise.
- 5: Standards: Except where more stringent requirements are noted or shown in the plans or specifications, all phases of work shall conform to the minimum standards of the 2010 C.B.C. adopted by the City of Santa Ana.
- 6. Building Live Loads: Fixed Seating -60 psf* *Reducible depending upon tributary area
- 7. Inspection: Wherever special and/or continuous inspection is called for in these notes or the building codes, such inspection shall be performed by a Testing Laboratory employed by the owner. Job site visits by the Engineer shall not constitute an official inspection.
- Other Trades: See architectural and consultant drawings for size and location of pipe, other openings, anchor bolt requirements for equipment and other details not shown on these structural drawings. All dimensions are to be checked and verified with the architectural
- 10. Materials and Workmanship: The Contractor shall supply all labor. materials, equipment and services of every kind, including water and power, necessary for the proper execution of the work shown or indicated on these drawings. All material shall be new materials. Subcontractors shall be skilled in their trade.
- 11. Materials and Workmanship Warranty: The Contractor shall replace any defective materials and correct poor workmanship with no additional costs to the owner, and shall remedy any defects in material or workmanship which appear in one year from the date of completion of the project. This warranty applies to the work done by the subcontractors as well as the work done by the employees of the contractor.
- 12. Safety: The Contractor shall adequately protect his work, adjacent property and the public, and be responsible for damage or injury due to his act or neglect.
- 13. Shop Drawings: Shop drawings are an old for field placement and are superseded by the structural drawings. It shall be the responsibility of the general contractor to make certain construction is in full agreement with the latest construction documents.
- 14. Shop Drawing Check: The review of shop drawings by the Structural Engineer is only for general compliance with the structural drawings and specifications. This review does not guarantee in any way that the shop drawings are correct nor does it infer that they supersede the structural drawinas.

STRUCTURAL STEEL NOTES:

1. Materials: All structural steel shapes shall conform to ASTM A992 Gr. 50. and all structural steel plates shall conform to ASTM A572 Gr. 50 unless noted otherwise. Structural steel pipe shall conform to ASTM A-53 grade B. Structural steel tube shall conform to ASTM A-500 grade B - 46ksi.

- 2. Welding: All welds shall be in conformity with the standard code for arc and gas welding of American Welding Society (AWS) and the American Institute of Steel Construction (AISC). All structural welding shall be performed by certified welders using the shielded electric arc process with approved electrodes. All welds shall be of min E70XX (70ksi) electrodes.
- 3. Shop Welding: Shop welding shall be performed only in the shop of an approved licensed fabricator
- 4. Field Welding: All field welding shall be performed by certified welders and shall be inspected by a Registered Special Inspector.
- 5. Bolts: All bolts shall be unfinished bolts conforming to ASTM A-307 unless noted otherwise.
- 6. Bolt Holes: Bolt holes in steel to be 1/16" larger diameter than the nominal balt size used except as noted otherwise.
- 7. Shop Drawings: Shop drawings shall be submitted to the Architect for review and comment prior to fabrication.
- 8. Detailing: All connections and detailing practice shall conform to the 9th Edition of A.I.S.C. specifications.
- 9. Certification: At completion of fabrication, the approved fabricator shall submit a certificate of compliance to the building official stating that the work was performed in accordance with the approved construction documents

WOOD NOTES:

- 1. Lumber: All lumber shall conform to the provision of the 2010 C.B.C. section 2303.
- 2. Lumber Gradina: All wood structural members shall be D.F. No. 1 per WCLIB Rule #17 (both horizontal and vertical), unless noted otherwise. All structural members shall be grade marked per Rule #17 of WCLIB.
- 3. Preserve—Treated & Fire—Retardant Lumber: Fasteners for preservative treated and fire retardant-treated wood shall be hot dipped zinccoated galvanized steel per ASTM A 153 or stainless steel. Fasteners other than nails, timber rivets, wood screws and lag screws shall be permitted to be of mechanically deposited zinc coated steel with cooting weights in accordance with ASTM B 695, Class 55 minimum. All other steel to be hot dipped zinc-coated galvanized or stainless steel.
- 4. Bolts: All bolt heads and nuts bearing on wood shall have washers. All bolt holes in wood shall be drilled 1/32" to 1/16" diameter larger than the nominal bolt diameter.
- 5. Lag Screws: All lag screws bearing on wood shall have washers. The hold for the shank shall be the same diameter and length as the unthreaded shank, the lead hole for the threads shall be about 70 percent of the shank diameter and length of the thread.
- 6. Wood Screws: The lead hale shall be about 70 percent of the root diameter of the screw and the length of the screw.
- 7. Nails: Nailing shall conform to Table 2304.9.1 of the 2010 C.B.C. Connections shown are minimum permissible. All nails shall be common wire noils unless noted otherwise. Where possible, noils driven perpendicular to the grain shall be used instead of toenails. Pre-drill members and renail should splitting develop due to the nature of the material or connection.
- 8. Plywood Sheathing: Plywood sheathing shall be D.F. plywood with exterior type glue (Exposure 1) as specified by the American Plywood Association and as noted on plans. Wood structural panels shall conform to requirements of DOC PS 1 or DOS PS 2. Noil as shown on plans. If the nail head breaks the face ply, the nail shall be removed and renailed into firm adjacent wood. Nails heads which break face ply shall be cause for rejection of vertical or horizontal diaphraams as installed.

9. OSB Sheathing: OSB sheathing shall be Exposure 1 D.F. as specified by the American Plywood Association and as noted on the plans. OSB structural panels shall conform to the requirements of DOC PS 2. Nail as shown on plans.

TimberSil Notes

- 1. TimberSil framing members, made with kiln dried Southern Yellow Pine No 1, or a better grade of Southern Yellow Pine, is manufactured by TimberSil, Springfield, Virginia.
- 2. Allowable bending stress Fb = 2700 psi minimum. Modules of Elasticity E = 19,000,000 psi minimum
- 3. Grade/Manufacturers Stamp: Members shall be stamped and inspected per the manufacturer.

STRUCTURAL OBSERVATION:

- 1. Structural observation is the visual observation of the structural system by a registered design professional for general conformance to the approved construction documents at significant construction stages and at completion of the structural system. Structural observation does not include or waive the responsibility of the inspection required by Sections 110 and 1704 or other sections of 2010 CBC.
- 2. The owner shall employ a registered design professional in responsible charge for the structural design, or another registered design professional designated by the registered design professional in responsible charge of the structural design, to perform structural observations as defined in Section 1702.
- 3. The owner or owner's representative shall coordinate and call for a meeting between the Engineer or Architect responsible for the structural design, structural observer, contractor, affected subcontractors, and deputy inspectors. The purpose of the meeting shall be to identify the major structural elements and connections that affect the vertical and lateral load systems of the structure and to review scheduling of the required observations.
- 4. The structural observer shall perform site visits at those steps in the progress of the work that allow for correction of deficiencies without substantial effort or uncovering of the work involved. At a minimum, the following significant construction stages require a site visit and an observation report from the structural observer:

Construction Stages

a) Guard Rails

Elements/Connections to be Observed Location, member size, attachment

b) Wood framing Joist, sheathing

- 5. At the conclusion of each significant construction stage, the structural observer shall submit to the building official a written statement that the site visits have been made and identify any reported deficiencies that, to the best of the structural observer's knowledge, have not been resolved.
- 6. At the conclusion of the work included in the permit, the structural observer shall submit to the building official a written statement that the site visits have been made and identify any reported deficiencies that, to the best of the structural observer's knowledge, have not been resolved.
- 7. The engineer of record shall develop all changes relating to the structural systems. The building department shall review and approve all changes to the approved plans and specifications



____ REF. SHEET \triangleleft α 2011 21147BS 10/03/2 NOTED SCALE DATE: Š

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2

JOB

NAILING	LOCATION
3-8d	toenail
2-8d	toenail each end
2-8d	face nail
3-8d	face nail
2-16d	blind and face nai
16d @ 16"o.c. 3-16d per 16"	typical foce nail braced wall panels
2-16d	end nail
4-8d 2-16d 2-20d	toenail end nail end nail
***********************	face nail
16d @ 16"o.c. 8-16d	typical face nail lap splice
3-8d	toenail
16d @ 6"o.c.	toenail
2-16d	face nail
16d @ 16"o.c.	along each edge
3-8d	toenail
4-8d	toenail
3-16d min	face nail
3-16d min	face nail
3-8d	toenail
2-8d	face noil
3-8d	face nail
3-8d	face nail
16d @ 24"o.c.	, \$666,666,666,666,666,666,666,666,666,6
	3-8d 2-8d 2-8d 3-8d 2-16d 16d @ 16"o.c. 3-16d per 16" 2-16d 4-8d 2-16d 2-20d 16d @ 24"o.c. 16d @ 16"o.c. 8-16d 3-8d 16d @ 6"o.c. 2-16d 16d @ 16"o.c. 3-8d 4-8d 3-16d min 3-16d min 3-8d 2-8d 3-8d 3-8d 3-8d 3-8d 3-8d 3-8d

NAILING SCHEDULE

⊕ DETAIL

scale ³/₄"=1'-0"





DETAI

SHEET REF.

SCALE: NOTED

10/03/2011

JOB NO.








DETAIL

scale ³/₄"=1'-0"



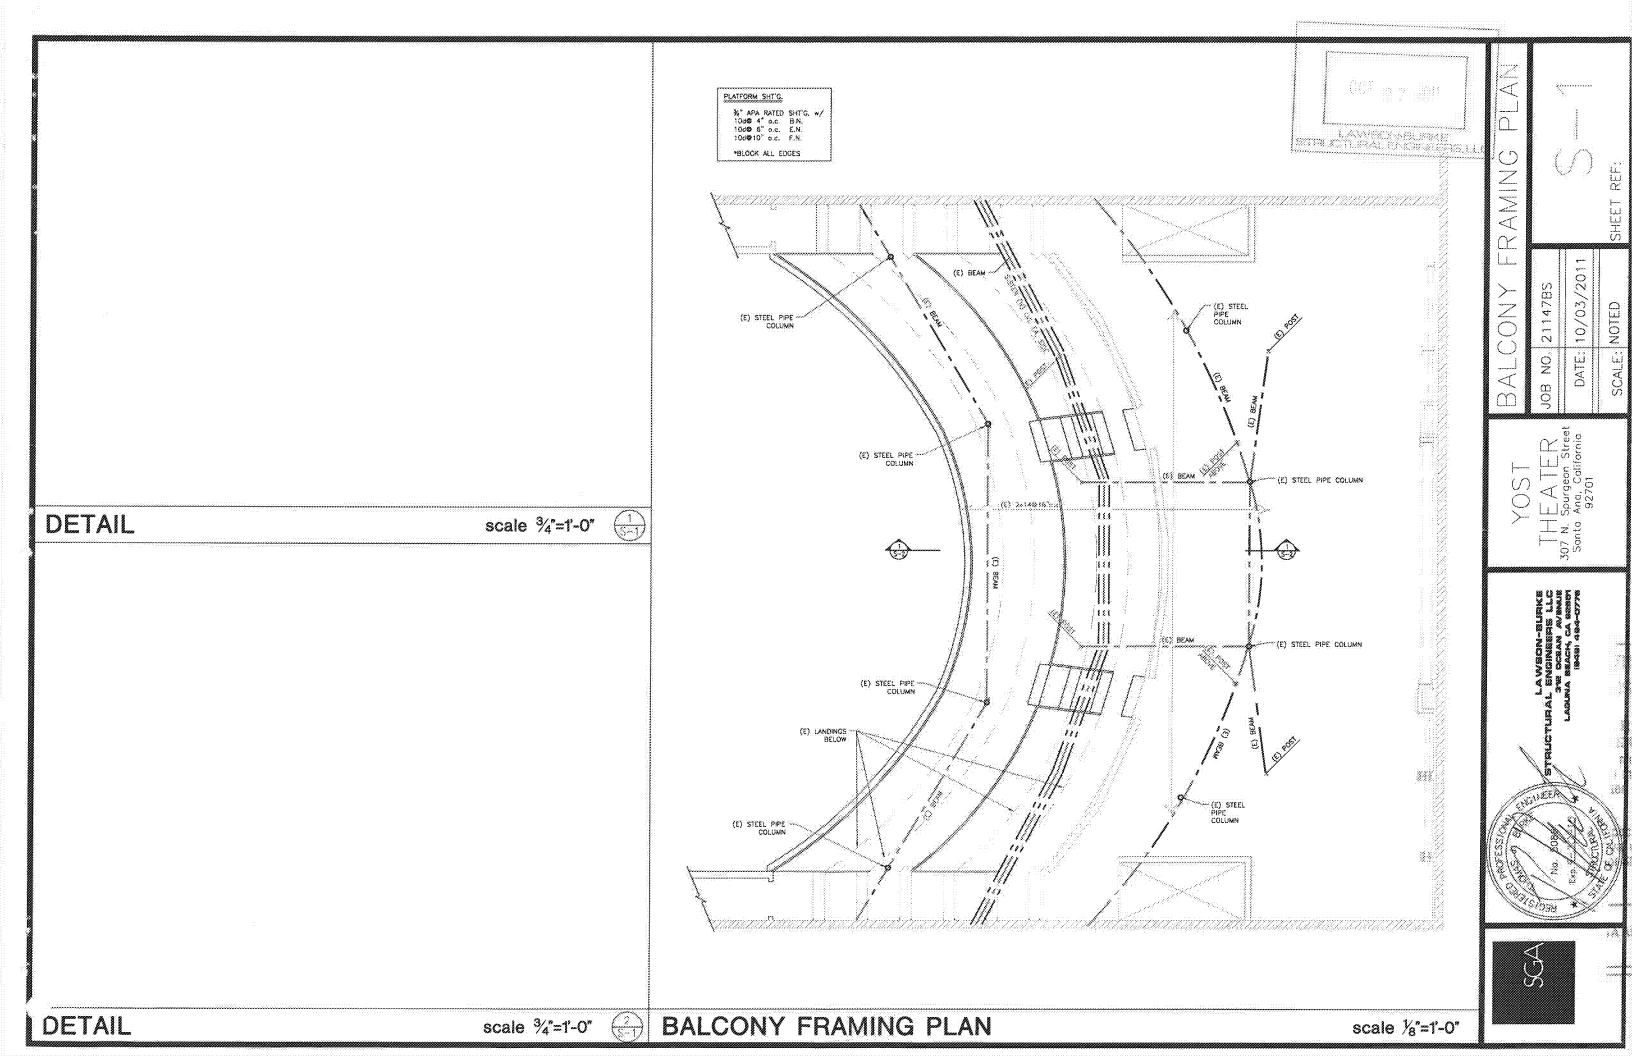

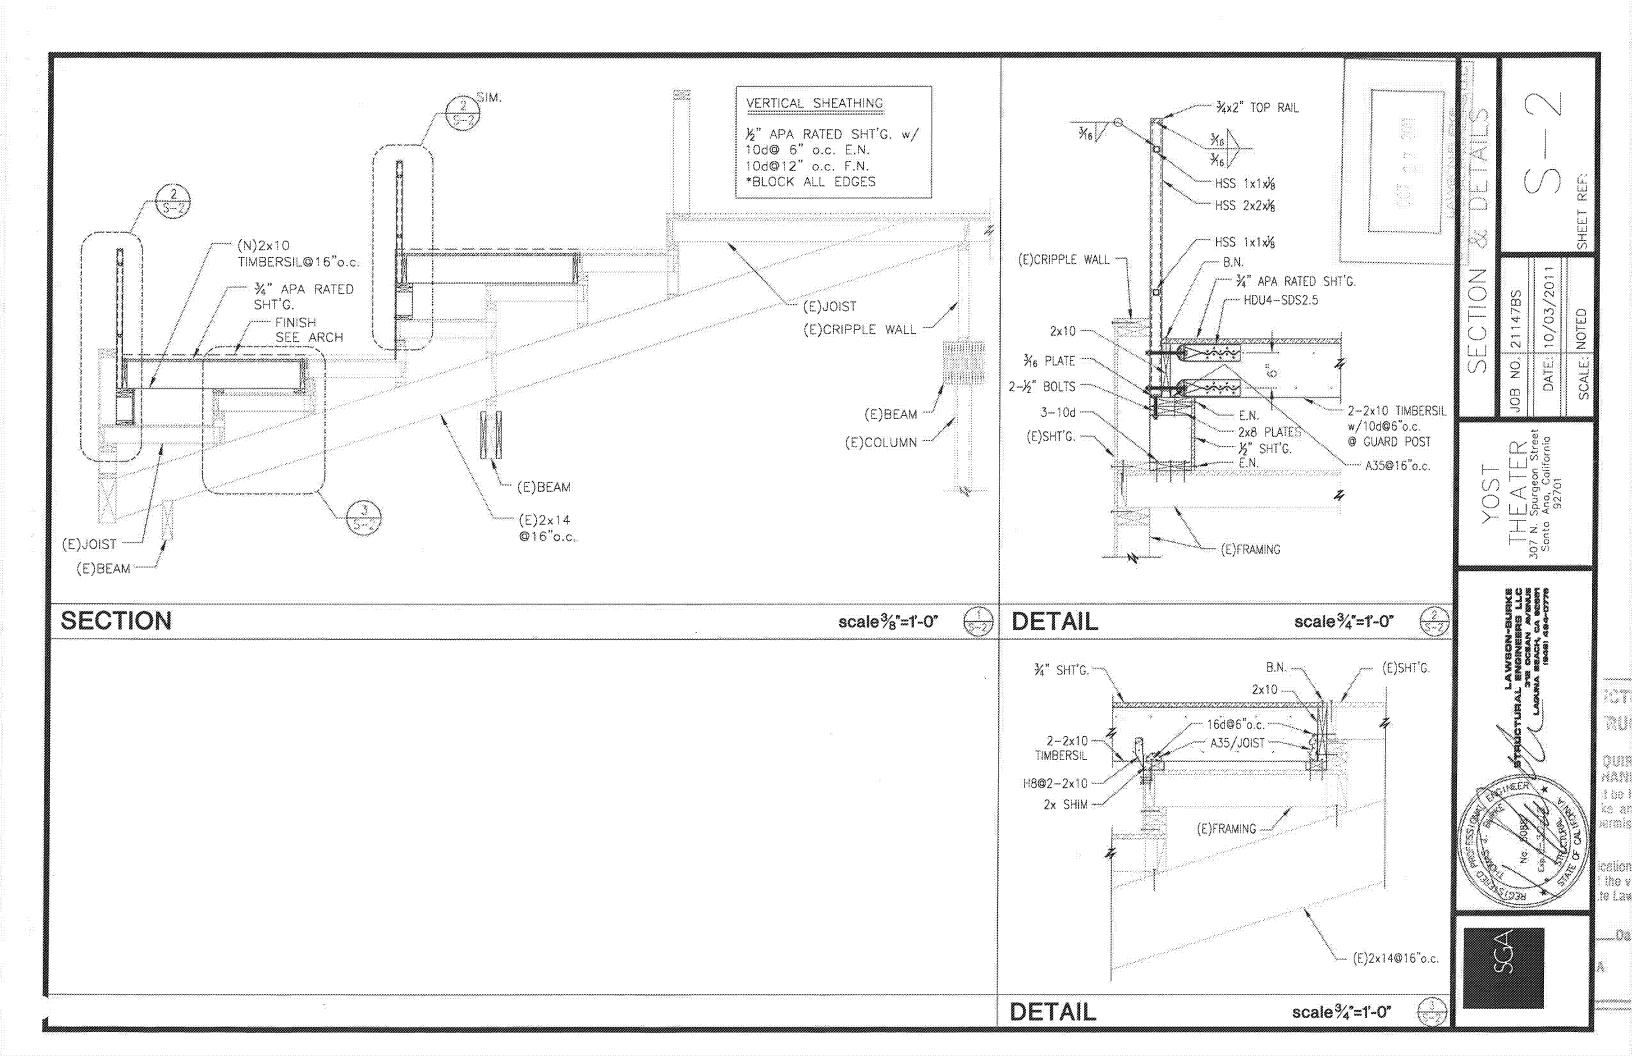

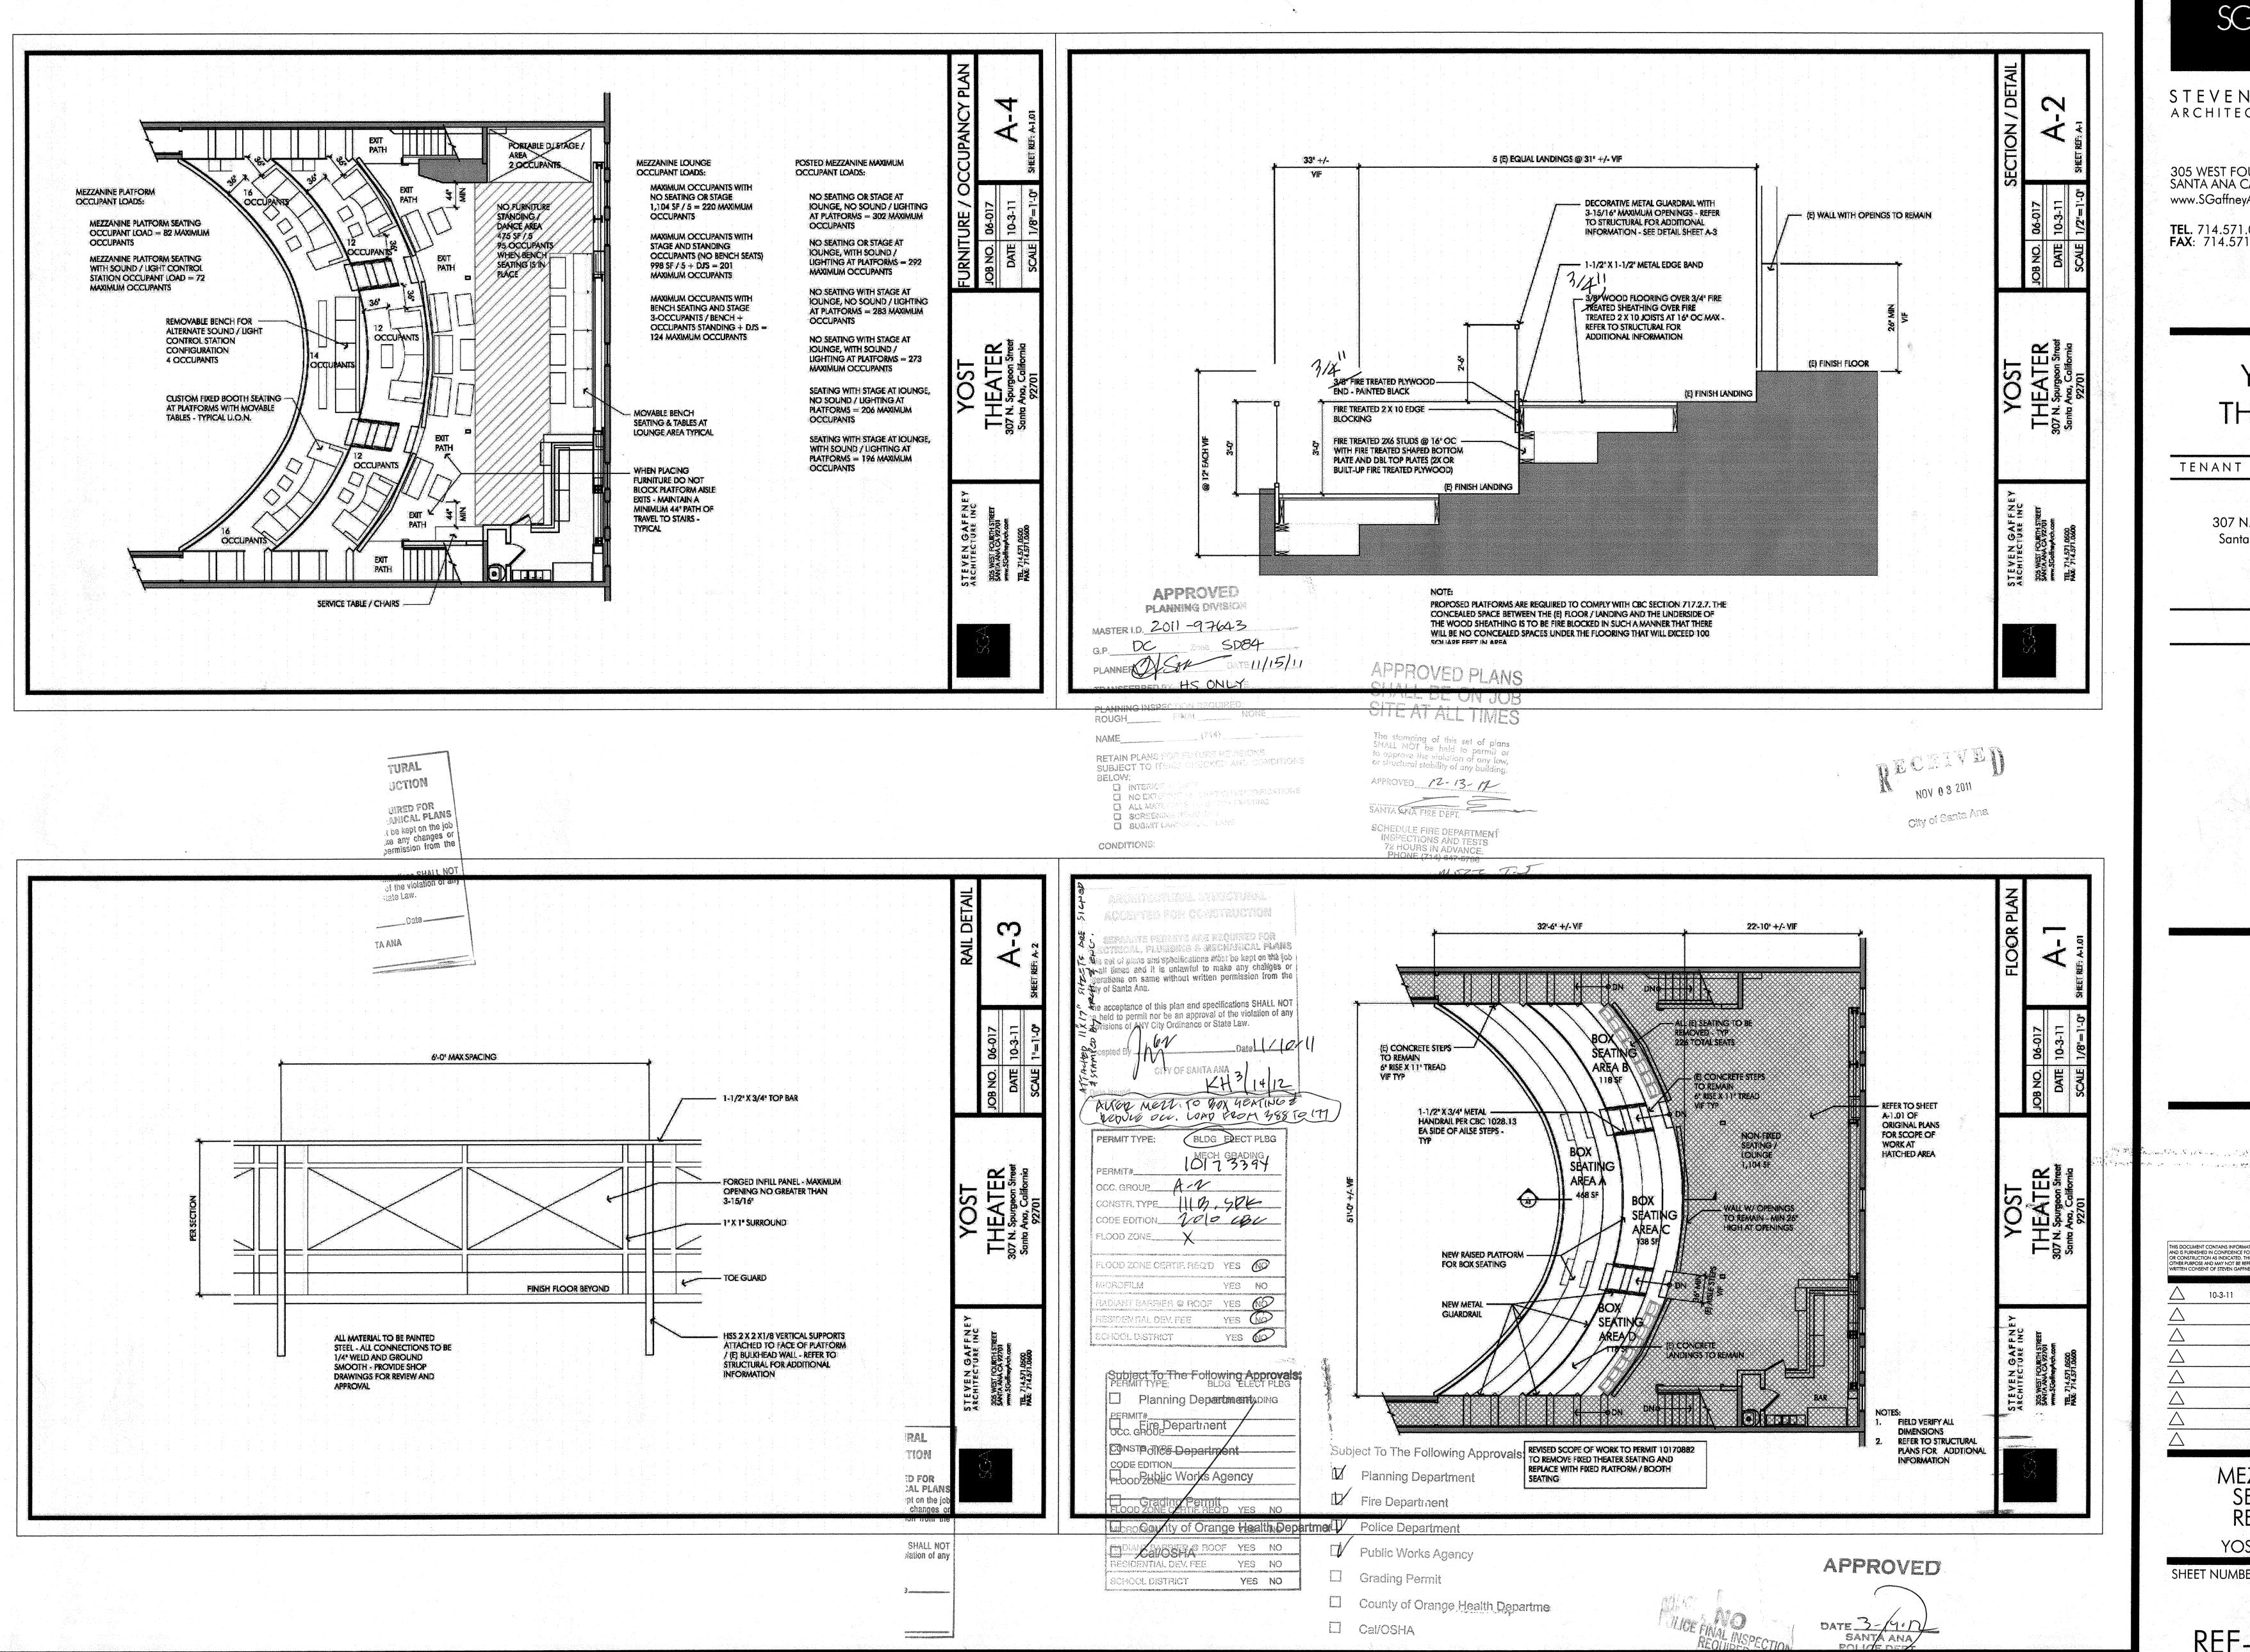



STEVENGAFFNEY ARCHITECTURE INC

305 WEST FOURTH STREET SANTA ANA CA 92701 www.SGaffneyArch.com

TEL. 714.571.0500 **FAX**: 714.571.0600

YOST THEATER

TENANT IMPROVEMENTS

307 N. Spurgeon Street Santa Ana, California 92701


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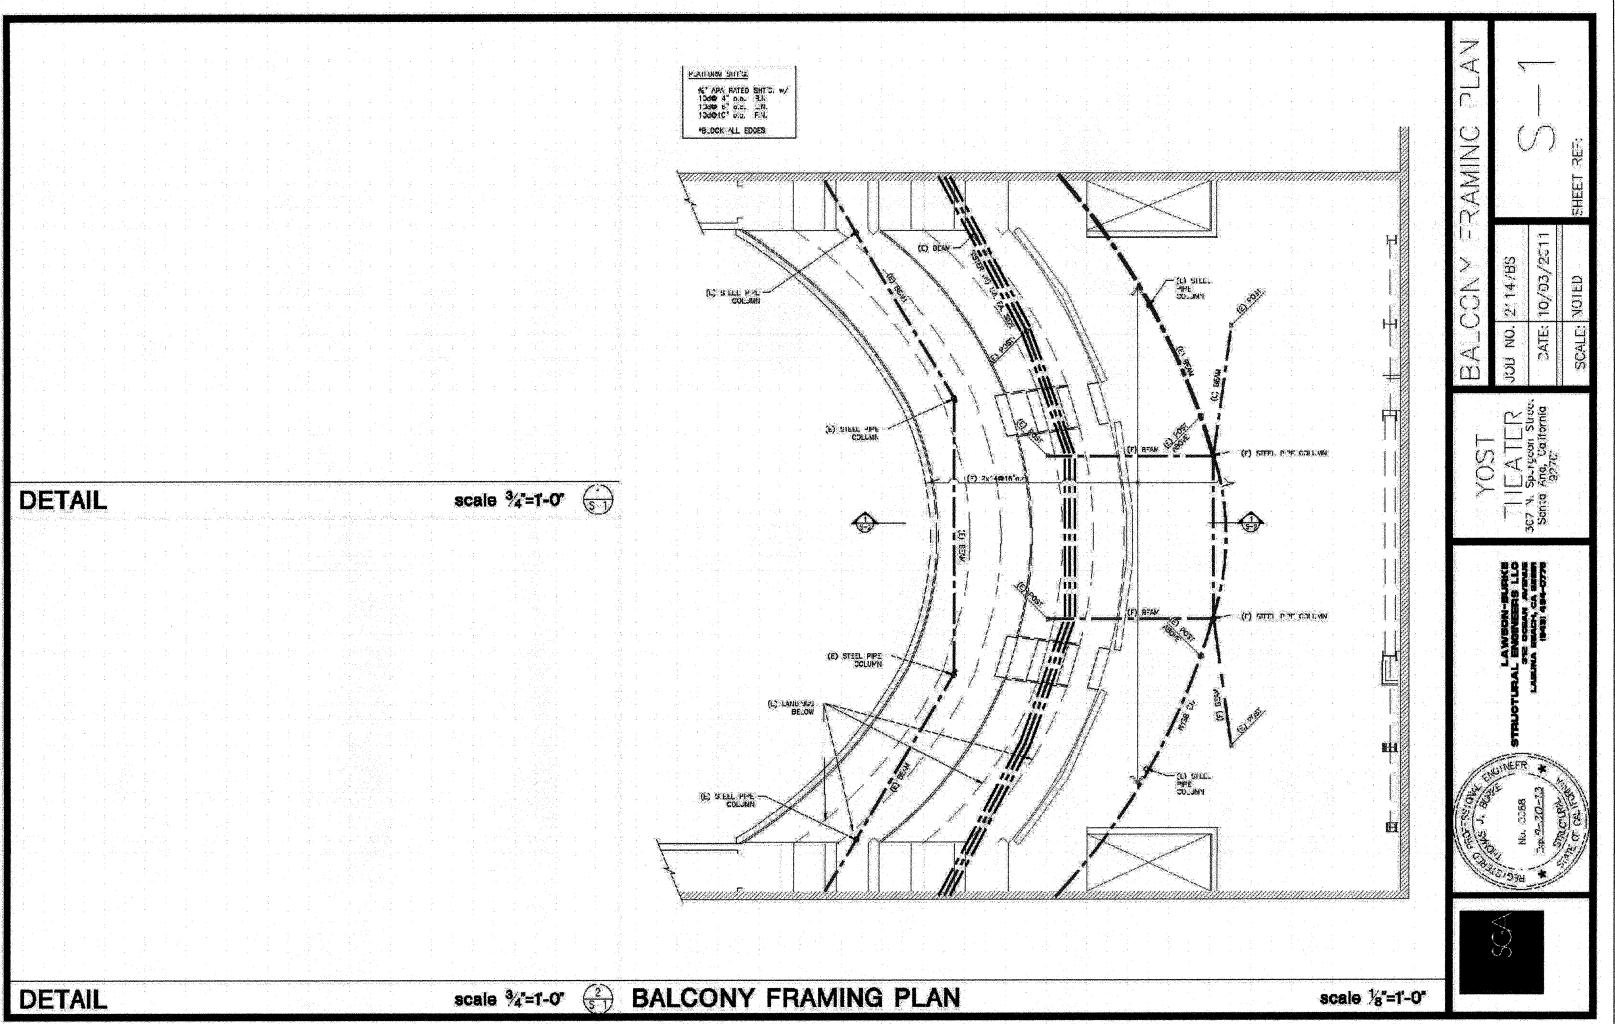
MEZZANINE SEATING REVISION


YOST THEATER


SHEET NUMBER JOB NUMBER

REF-1



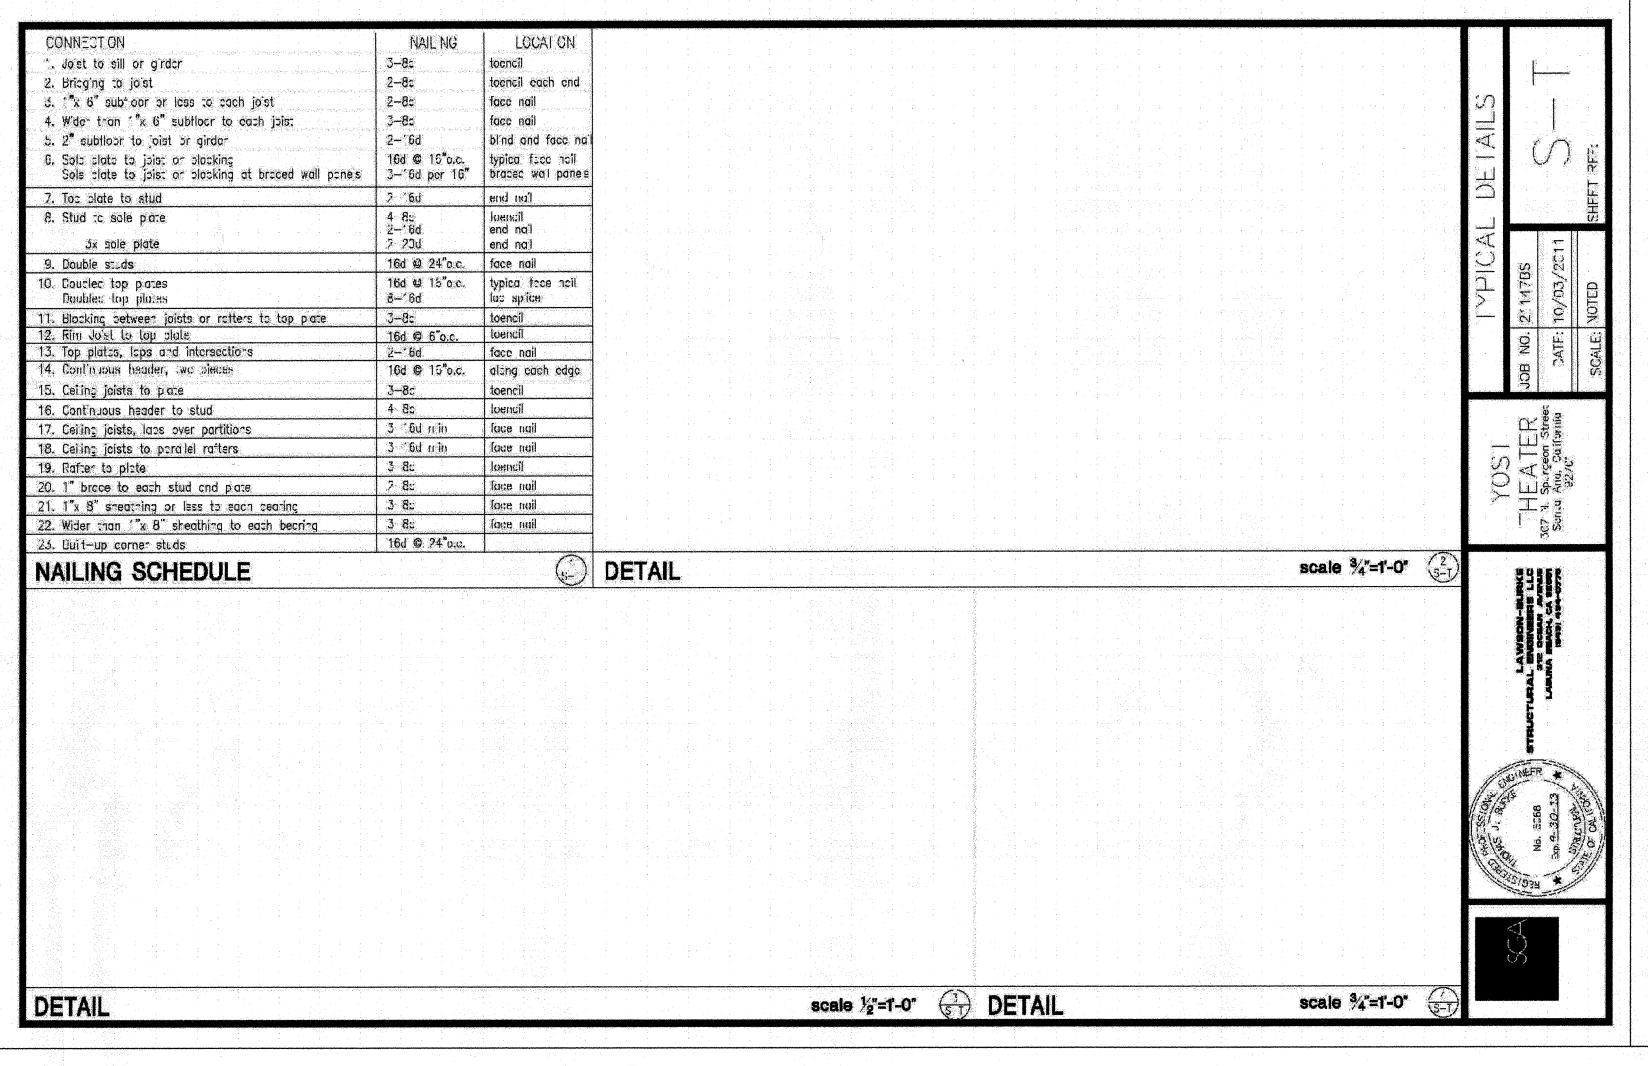

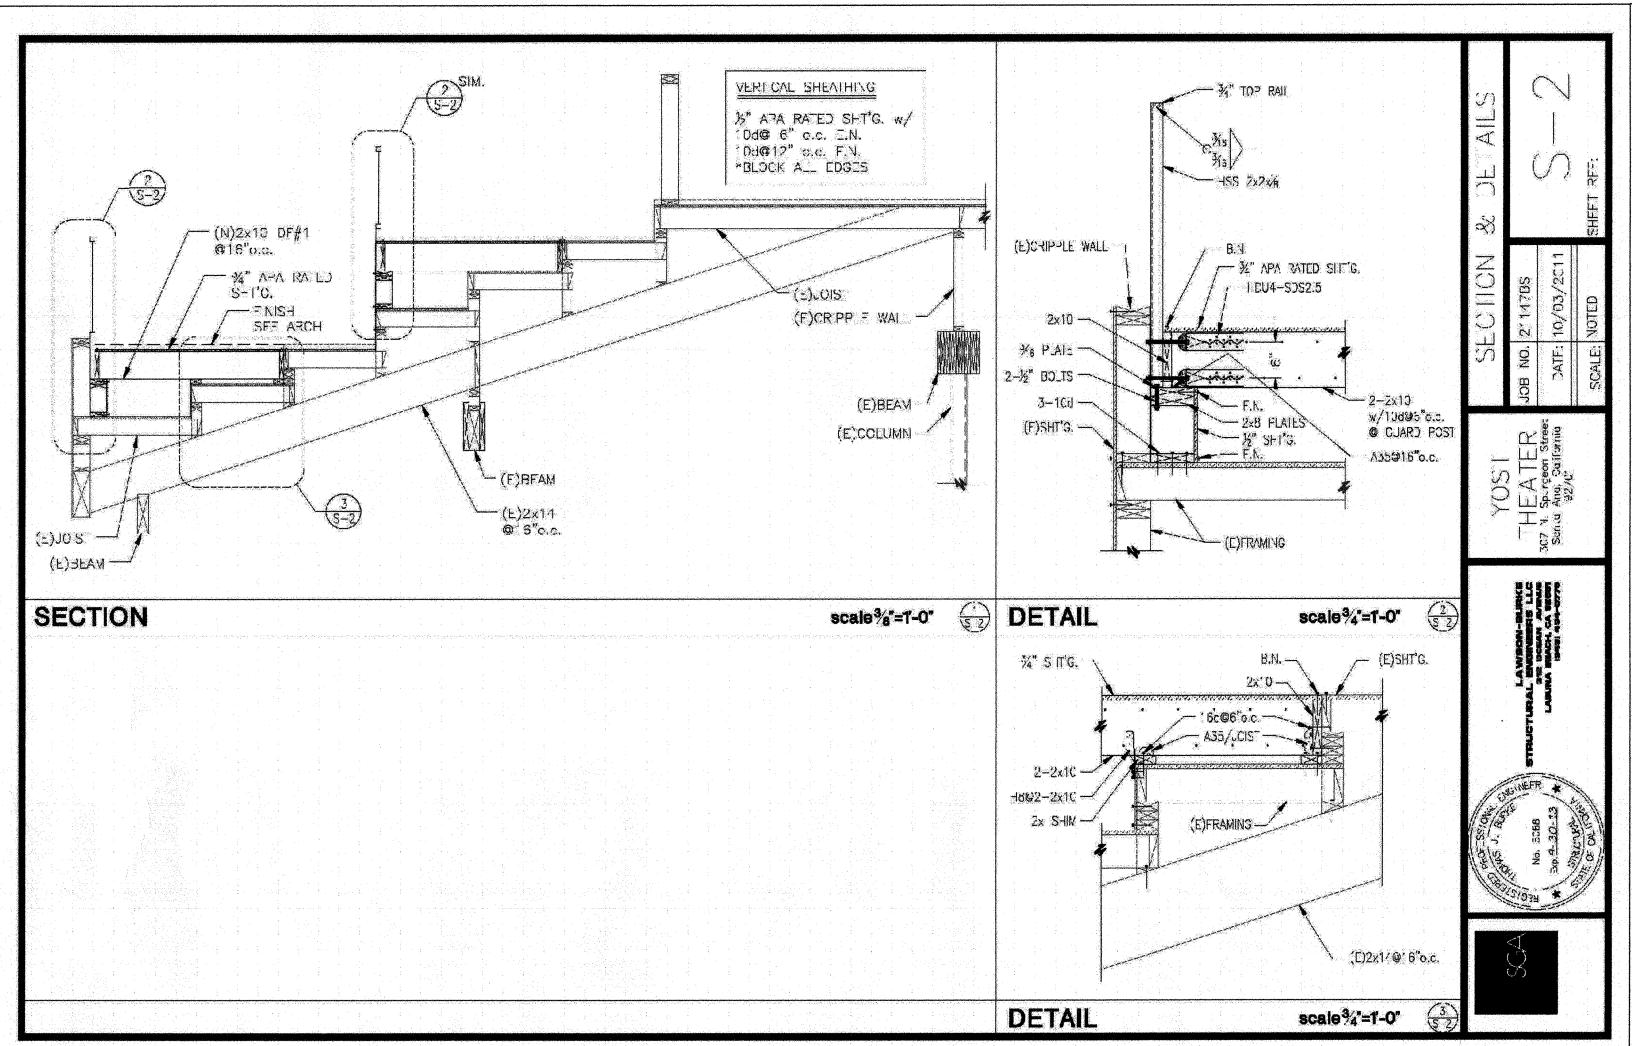

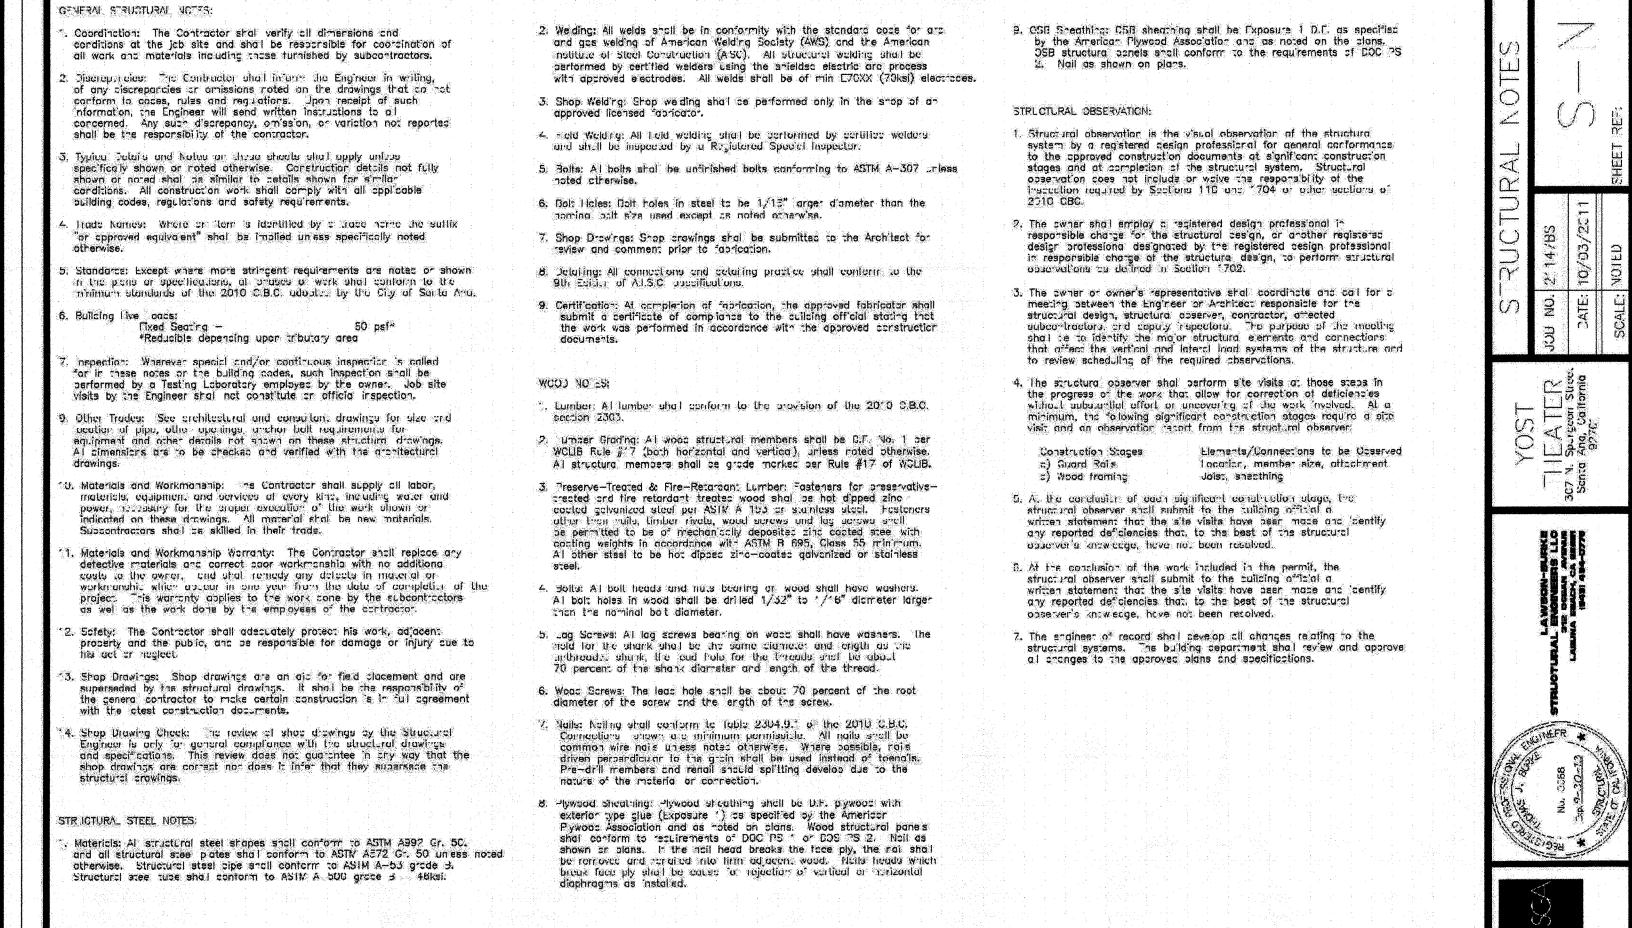

STRUCTURAL NOTES



STEVEN GAFFNEY ARCHITECTURE INC


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TEL. 714.571.0500 **FAX**: 714.571.0600

YOST THEATER

TENANT IMPROVEMENTS

307 N. Spurgeon Street Santa Ana, California 92701

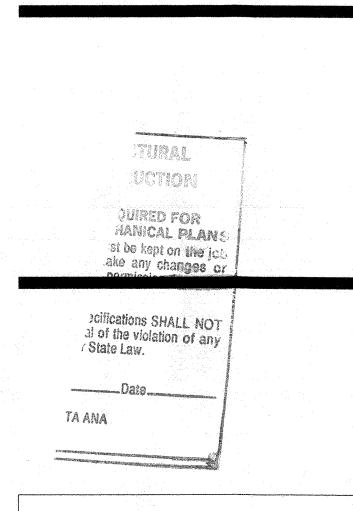

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MEZZANINE SEATING **REVISION**

YOST THEATER

JOB NUMBER SHEET NUMBER

STATE LICENSE NO. 471687 "Established 1980"

December 5, 2011

Mr. Kevin Jeffries Yost Theater 307 Spurgeon Street Santa Ana, CA 92701

Re: Fire Sprinkler Coverage

Kevin:


On 8/16/11 our field superintendent Allen Parza did a field survey of your automatic fire sprinkler system, to determine if the attic space between the kitchen ceiling and balcony area had proper fire sprinkler coverage. After his survey he determined that there was proper coverage as per NFPA 13, state and local codes.


If you have any questions or need any further information please give me a call at (909) 622-8911. I will be happy to assist you.

Regards?

Pete Rosell Vice President

Inland Empire Fire and Safety, Inc.

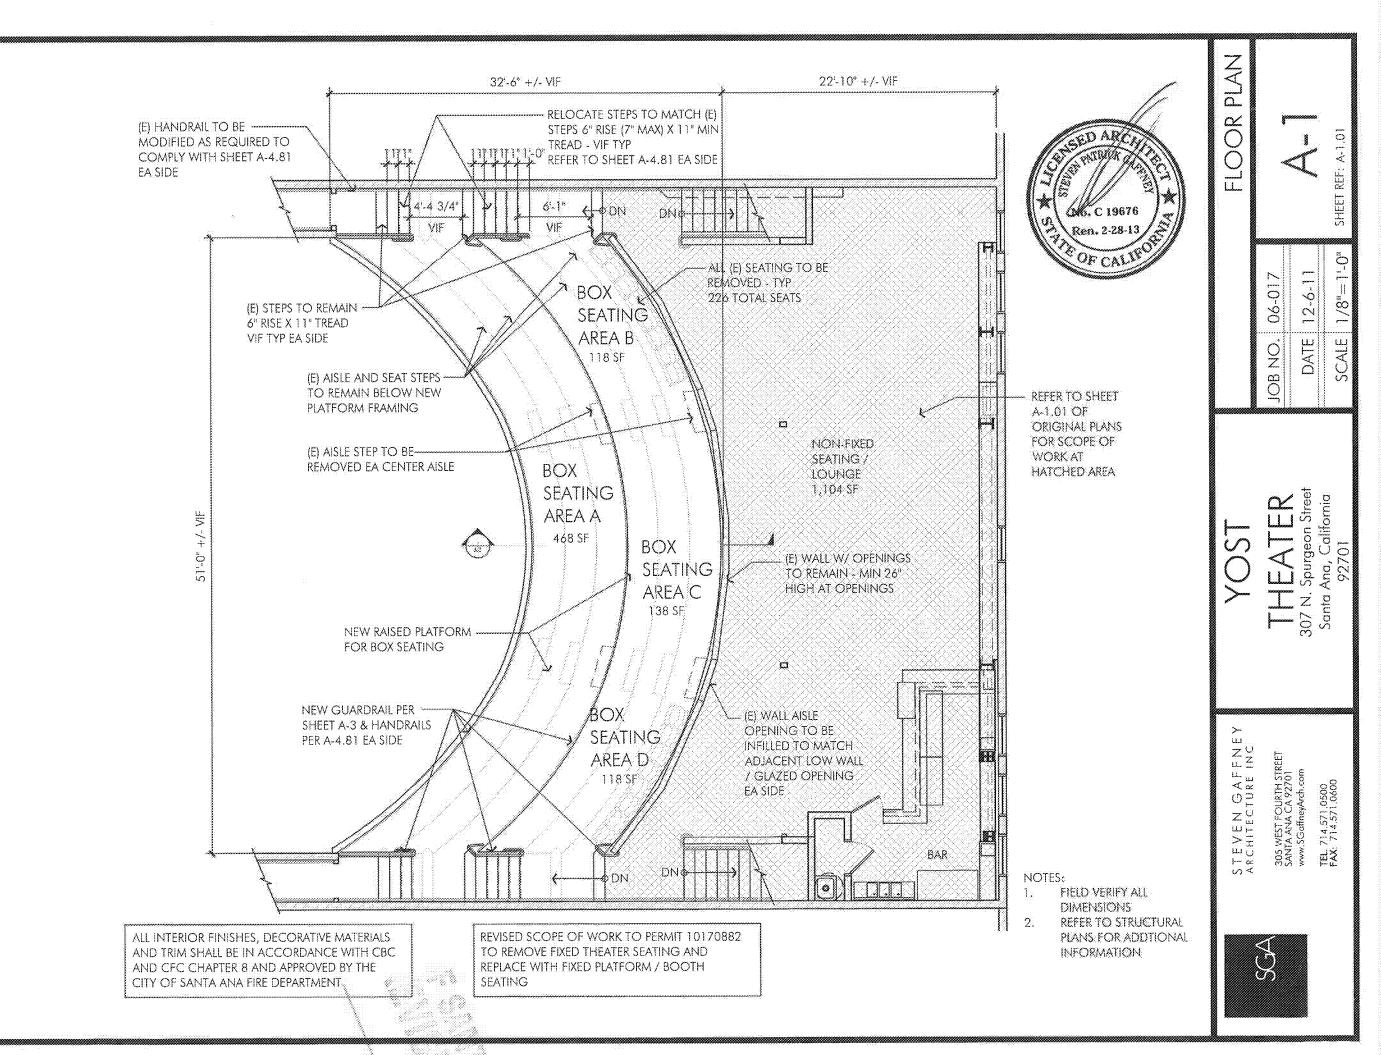

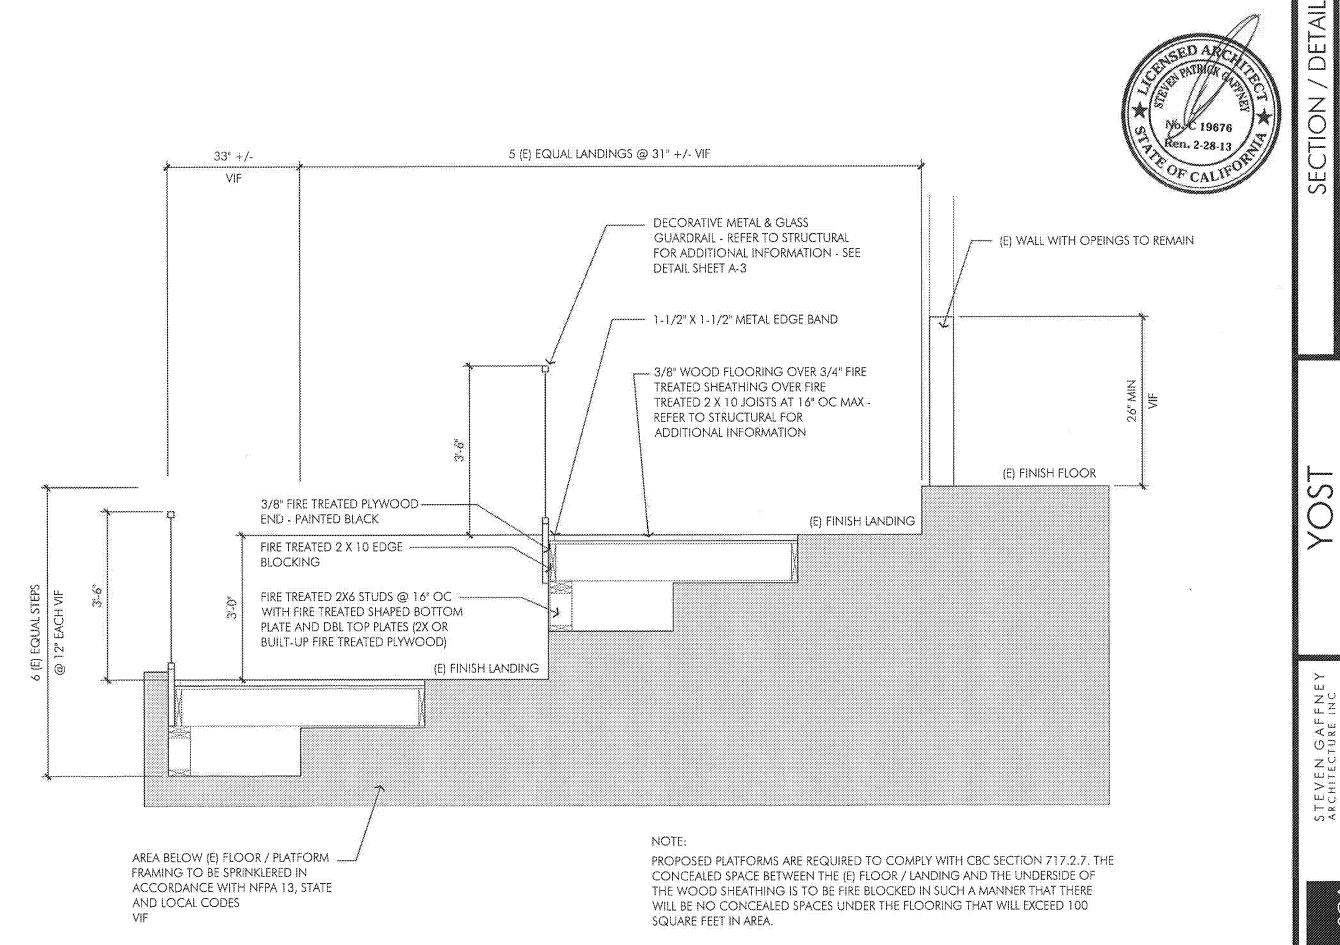

06-017


JOB NO.

12-6-1

THEATER
307 N. Spurgeon Street
Santa Ana, California
92701

305 WEST FOURTH STREET SANTA ANA CA 92701 www.SGaffneyArch.com

TEL 714.571.0500 FAX: 714.571.0600

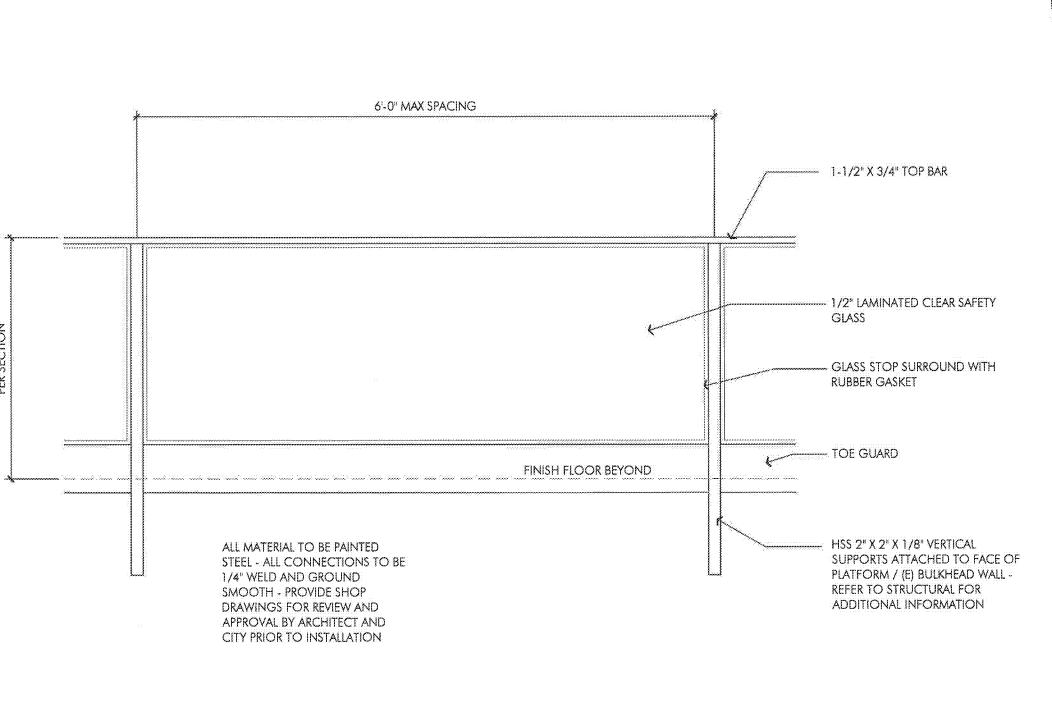

RAIL DETAIL

SHEET REF: A-2

SCALE

12-6-11

DATE


06-017

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305 WEST FOURTH STREET SANTA ANA CA 92701 www.SGaffneyArch.com

TEL 714.571.0500 FAX: 714.571.0600

STEVEN GAFFNEY

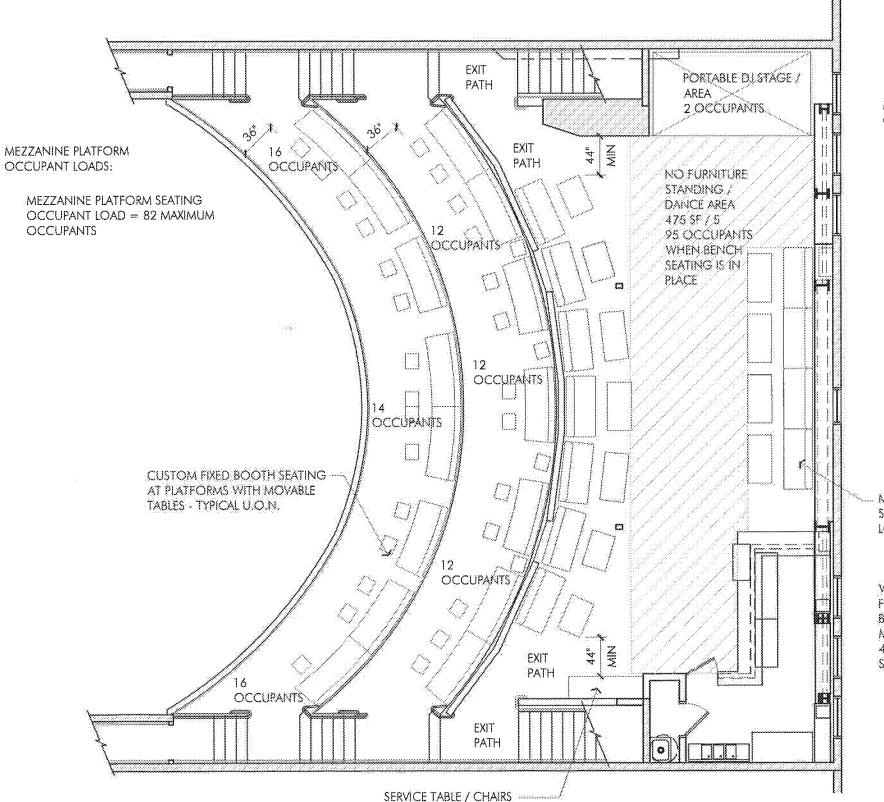

MEZZANINE LOUNGE OCCUPANT LOADS:

> MAXIMUM OCCUPANTS WITH NO SEATING OR STAGE 1,104 SF / 5 = 220 MAXIMUM**OCCUPANTS**

MAXIMUM OCCUPANTS WITH STAGE AND STANDING OCCUPANTS (NO BENCH SEATS) 998 SF / 5 + DJ'S = 201 MAXIMUM OCCUPANTS

MAXIMUM OCCUPANTS WITH BENCH SEATING AND STAGE 3-OCCUPANTS / BENCH + OCCUPANTS STANDING + DJS = 124 MAXIMUM OCCUPANTS

MOVABLE BENCH SEATING & TABLES AT LOUNGE AREA TYPICAL

WHEN PLACING FURNITURE DO NOT BLOCK EXIT PATH -MAINTAIN A MINIMUM 44" PATH OF TRAVEL TO STAIRS - TYPICAL

POSTED MEZZANINE MAXIMUM OCCUPANT LOADS:

> NO SEATING OR STAGE AT LOUNGE = 302 MAXIMUM **OCCUPANTS**

NO SEATING WITH STAGE AT LOUNGE = 283 MAXIMUM **OCCUPANTS**

SEATING WITH STAGE AT LOUNGE = 206 MAXIMUM OCCUPANTS



OCCUPANCY

FURNIUR

THEATER
307 N. Spurgeon Street
Santa Ana, California
92701

12-6-11

DATE

JOB NO.

STEVEN GAFFNEY 305 WEST FOURTH STREET SANTA ANA CA 92701 www.SGaffneyArch.com

FAX: 714.571.0500

GENERAL STRUCTURAL NOTES

- Coordination: The Contractor shall verify all dimensions and conditions at the job site and shall be responsible for coordination of all work and materials including those furnished by subcontractors.
- 2. Discrepancies: The Contractor shall inform the Engineer in writing, of any discrepancies or omissions noted on the drawings that do not conform to codes, rules and regulations. Upon receipt of such information, the Engineer will send written instructions to all concerned. Any such discrepancy, omission, or variation not reported shall be the responsibility of the contractor.
- 3. Typical Details and Notes on these sheets shall apply unless specifically shown or noted otherwise. Construction details not fully shown or noted shall be similar to details shown for similar conditions. All construction work shall comply with all applicable building codes, regulations and safety requirements.
- Trade Names: Where an item is identified by a trade name the suffix "or approved equivalent" shall be implied unless specifically noted otherwise.
- Standards: Except where more stringent requirements are noted or shown in the plans or specifications, all phases of work shall conform to the minimum standards of the 2010 C.B.C. adopted by the City of Santa Ana.
- 6. Building Live Loads:

 Fixed Seating 60 psf*

 *Reducible depending upon tributary area
- 7. Inspection: Wherever special and/or continuous inspection is called for in these notes or the building codes, such inspection shall be performed by a Testing Laboratory employed by the owner. Job site visits by the Engineer shall not constitute an official inspection.
- Other Trades: See architectural and consultant drawings for size and location of pipe, other openings, anchor bolt requirements for equipment and other details not shown on these structural drawings.
 All dimensions are to be checked and verified with the architectural drawings.
- 10. Materials and Workmanship: The Contractor shall supply all labor, materials, equipment and services of every kind, including water and power, necessary for the proper execution of the work shown or indicated on these drawings. All material shall be new materials. Subcontractors shall be skilled in their trade.
- 11. Materials and Workmanship Warranty: The Contractor shall replace any defective materials and correct poor workmanship with no additional costs to the owner, and shall remedy any defects in material or workmanship which appear in one year from the date of completion of the project. This warranty applies to the work done by the subcontractors as well as the work done by the employees of the contractor.
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- 13. Shop Drawings: Shop drawings are an aid for field placement and are superseded by the structural drawings. It shall be the responsibility of the general contractor to make certain construction is in full agreement with the latest construction documents.
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STRUCTURAL STEEL NOTES:

Materials: All structural steel shapes shall conform to ASTM A992 Gr. 50. and all structural steel plates shall conform to ASTM A572 Gr. 50 unless noted otherwise. Structural steel pipe shall conform to ASTM A-53 grade B. Structural steel tube shall conform to ASTM A-500 grade B - 46ksi.

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- 4. Field Welding: All field welding shall be performed by certified welders and shall be inspected by a Registered Special Inspector.
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WOOD NOTES:

- Lumber: All lumber shall conform to the provision of the 2010 C.B.C. section 2303.
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- 5. Lag Screws: All lag screws bearing on wood shall have washers. The hold for the shank shall be the same diameter and length as the unthreaded shank, the lead hole for the threads shall be about 70 percent of the shank diameter and length of the thread.
- 6. Wood Screws: The lead hole shall be about 70 percent of the root diameter of the screw and the length of the screw.
- 7. Nails: Nailing shall conform to Table 2304.9.1 of the 2010 C.B.C. Connections shown are minimum permissible. All nails shall be common wire nails unless nated otherwise. Where possible, nails driven perpendicular to the grain shall be used instead of toenails. Pre-drill members and renail should splitting develop due to the nature of the material or connection.
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9. OSB Sheathing: OSB sheathing shall be Exposure 1 D.F. as specified by the American Plywood Association and as noted on the plans. OSB structural panels shall conform to the requirements of DOC PS 2. Nail as shown on plans.

TimberSil Notes

- TimberSil framing members, made with kiln dried Southern Yellow Pine No 1, or a better grade of Southern Yellow Pine, is manufactured by TimberSil, Springfield, Virginia.
- Allowable bending stress Fb = 2700 psi minimum. Modules of Elasticity E = 19,000,000 psi minimum
- Grade/Manufacturers Stamp: Members shall be stamped and inspected per the manufacturer.

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- 2. The owner shall employ a registered design professional in responsible charge for the structural design, or another registered design professional designated by the registered design professional in responsible charge of the structural design, to perform structural observations as defined in Section 1702.
- 3. The owner or owner's representative shall coordinate and call for a meeting between the Engineer or Architect responsible for the structural design, structural observer, contractor, affected subcontractors, and deputy inspectors. The purpose of the meeting shall be to identify the major structural elements and connections that affect the vertical and lateral load systems of the structure and to review scheduling of the required observations.
- 4. The structural observer shall perform site visits at those steps in the progress of the work that allow for correction of deficiencies without substantial effort or uncovering of the work involved. At a minimum, the following significant construction stages require a site visit and an observation report from the structural observer:

Construction Stages
a) Guard Rails

b) Wood framing

Elements/Connections to be Observed Location, member size, attachment Joist, sheathing

- 5. At the conclusion of each significant construction stage, the structural observer shall submit to the building official a written statement that the site visits have been made and identify any reported deficiencies that, to the best of the structural observer's knowledge, have not been resolved.
- 6. At the conclusion of the work included in the permit, the structural observer shall submit to the building official a written statement that the site visits have been made and identify any reported deficiencies that, to the best of the structural observer's knowledge, have not been resolved.
- 7. The engineer of record shall develop all changes relating to the structural systems. The building department shall review and approve all changes to the approved plans and specifications.

OCT 2 7 2011

LAWSCN-BURKE Structural de la company d


JOB NO. 21147BS DATE: 10/03/2011 SHEET

NOTED

SCALE

THEATER

O7 N. Spurgeon Street
Santa Ana, California

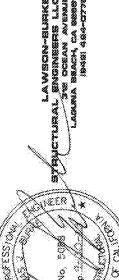



CONNECTION	NAILING	LOCATION
1. Joist to sill or girder	3-8d	toenail
2. Bridging to joist	2-8d	toenail each end
3. 1"x 6" subfloor or less to each joist	2-8d	face nail
4. Wider than 1"x 6" subfloor to each joist	3-8d	face nail
5. 2" subfloor to joist or girder	2-16d	blind and face na
 Sole plate to joist or blocking Sole plate to joist or blocking at braced wall panels 	16d @ 16"o.c. 3-16d per 16"	typical face nail braced wall panels
7. Top plate to stud	2-16d	end nail
8. Stud to sole plate 3x sole plate	4-8d 2-16d 2-20d	toenail end nail end nail
9. Double studs	16d @ 24"o.c.	face nail
10. Doubled top plates Doubled top plates	16d @ 16"o.c. 8-16d	typical face nail lap splice
11. Blocking between joists or rafters to top plate	3-8d	toenail
12. Rim Joist to top plate	16d @ 6"o.c.	toenail
13. Top plates, laps and intersections	2-16d	face nail
14. Continuous header, two pieces	16d @ 16"o.c.	along each edge
15. Ceiling joists to plate	3-8d	toenail
16. Continuous header to stud	4-8d	toenail
17. Ceiling joists, laps over partitions	3-16d min	foce nail
18. Ceiling joists to parallel rafters	3-16d min	face nail
19. Rafter to plate	3-8d	toenail
20. 1" brace to each stud and plate	2-8d	face nail
21, 1"x 8" sheathing or less to each bearing	38d	face nail
22. Wider than 1"x 8" sheathing to each bearing	38d	face nail
23. Built-up corner studs	16d @ 24"o.c.	


NAILING SCHEDULE

⊕ DETAIL

scale 3/4"=1'-0"





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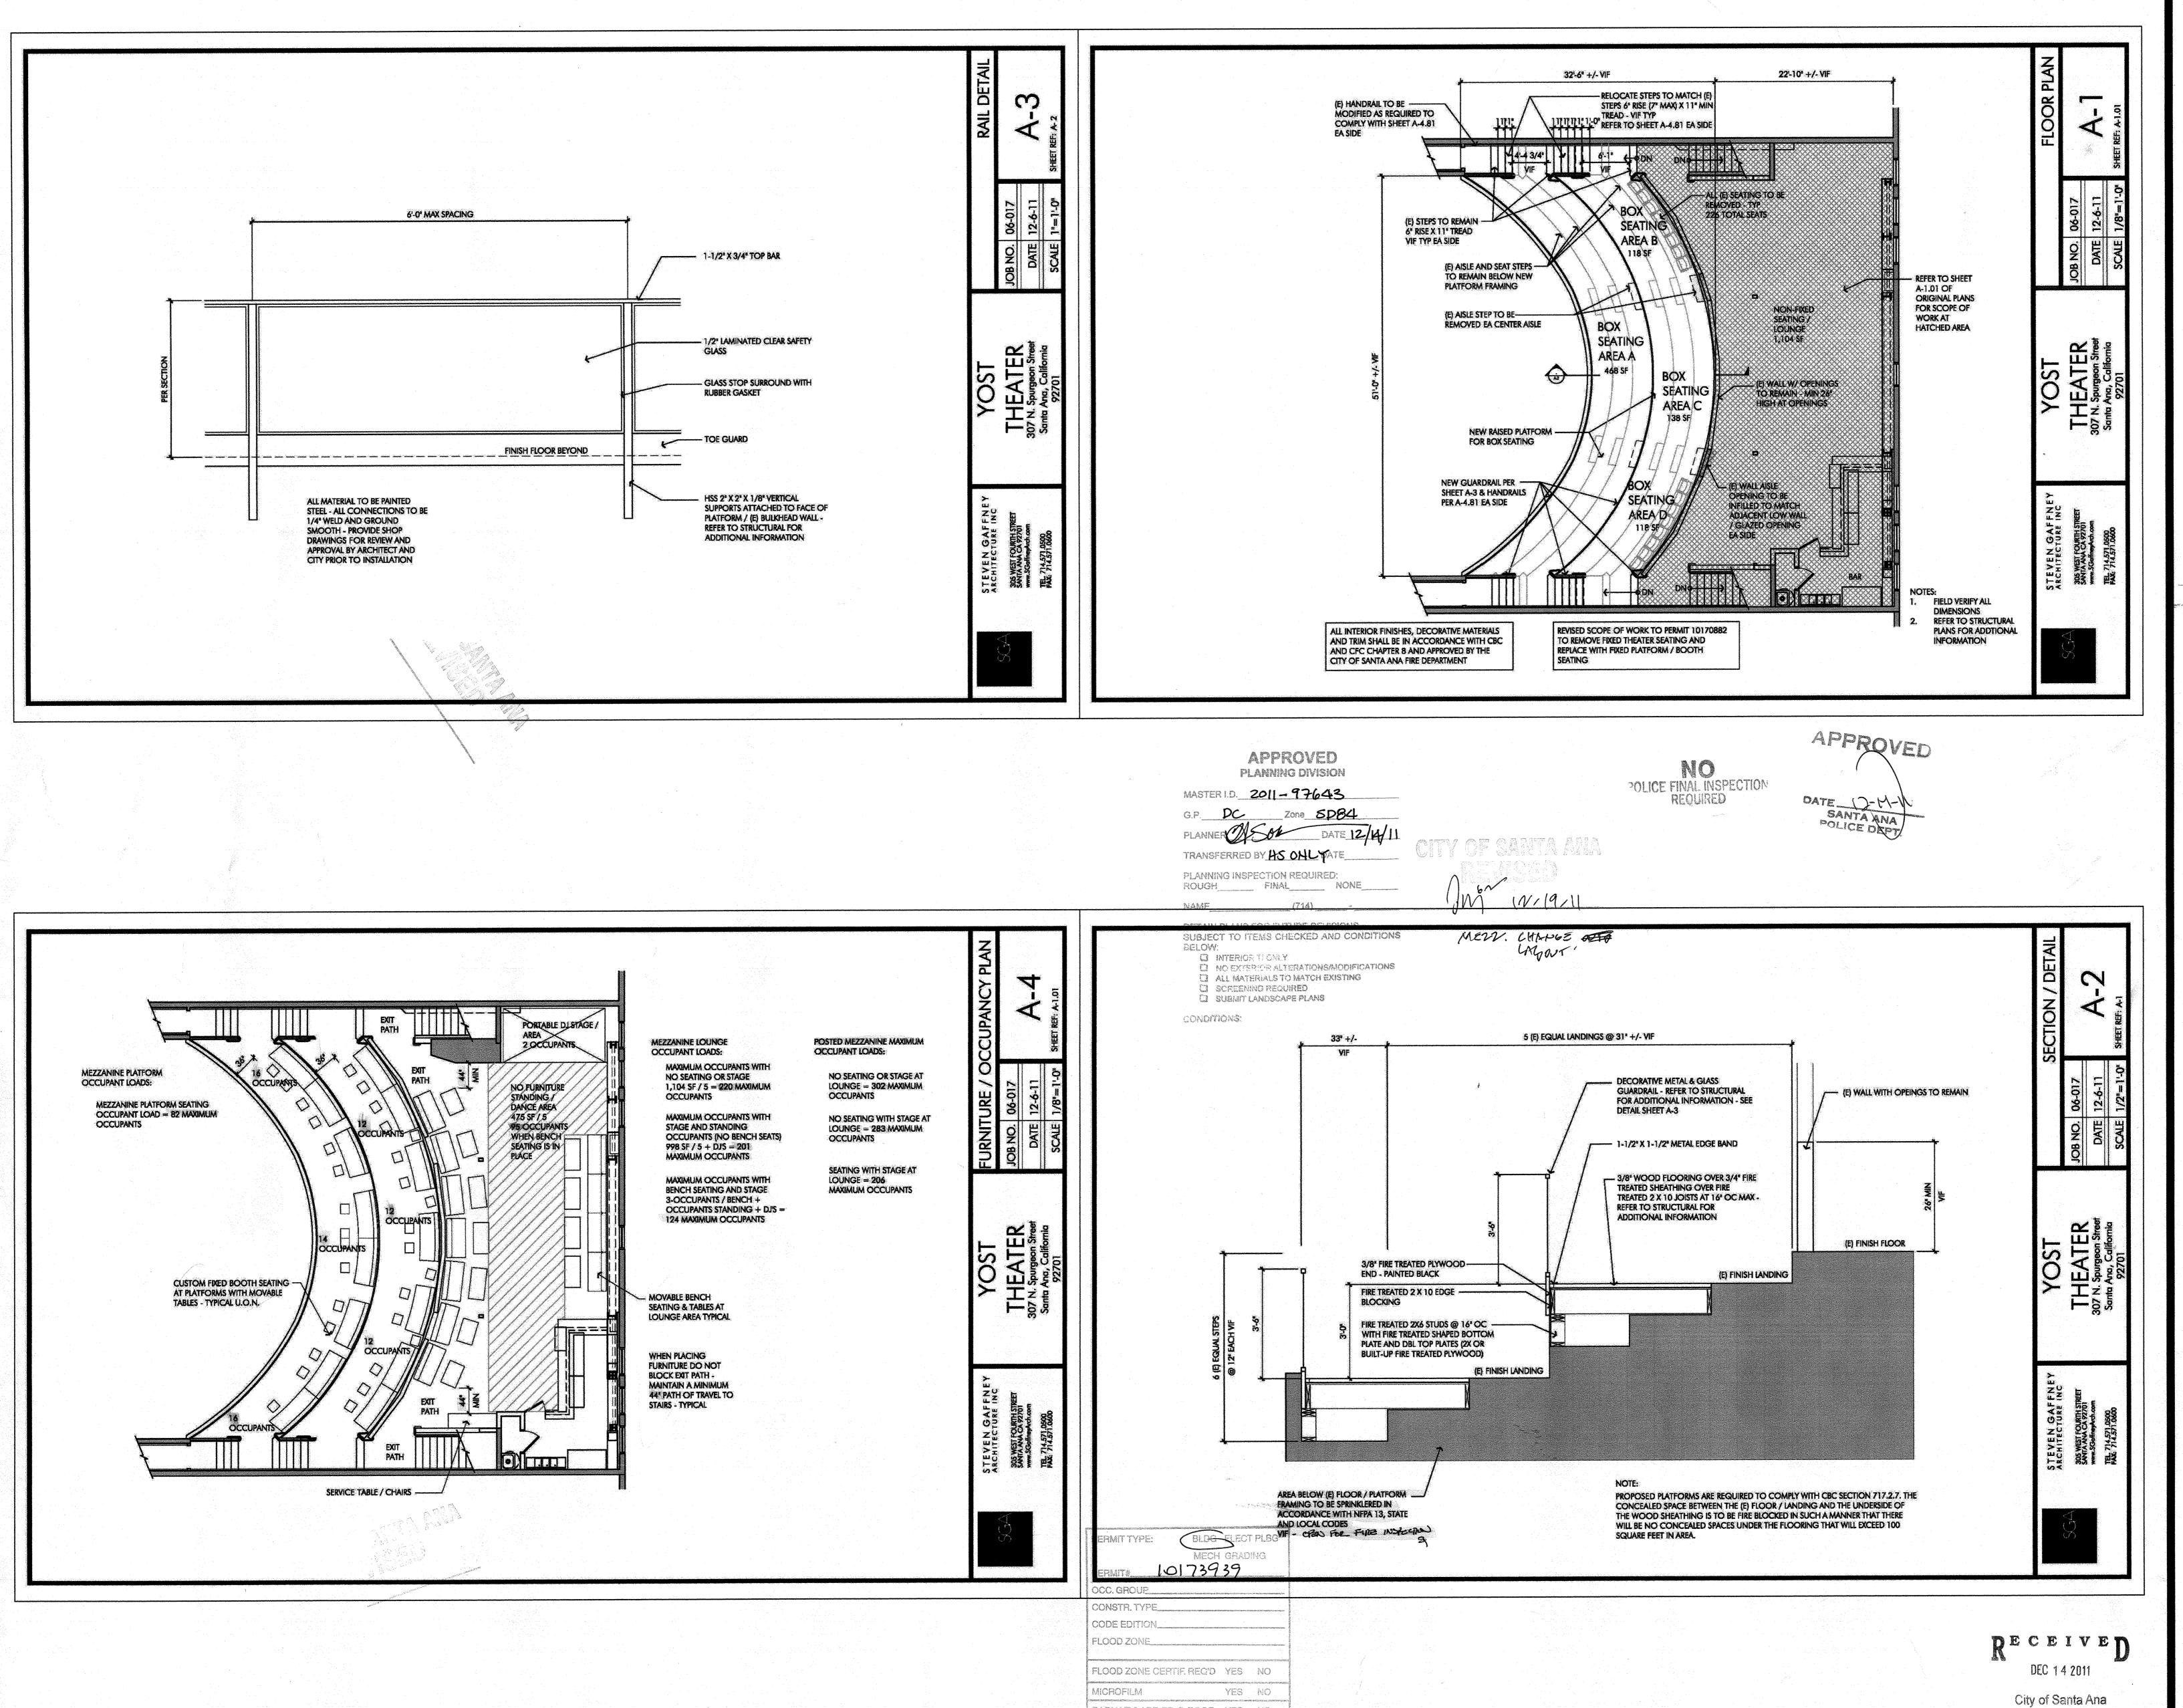


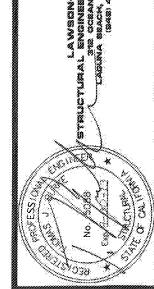

Planning & Building Agency Building Safety Division 20 Civic Center Plaza P.O. Box 1988 (M-19) Santa Ana, CA 92702 (714) 647-5800 www.santa-ana.org

REVISION/SUPPLEMENTAL PLAN CHECK REQUEST

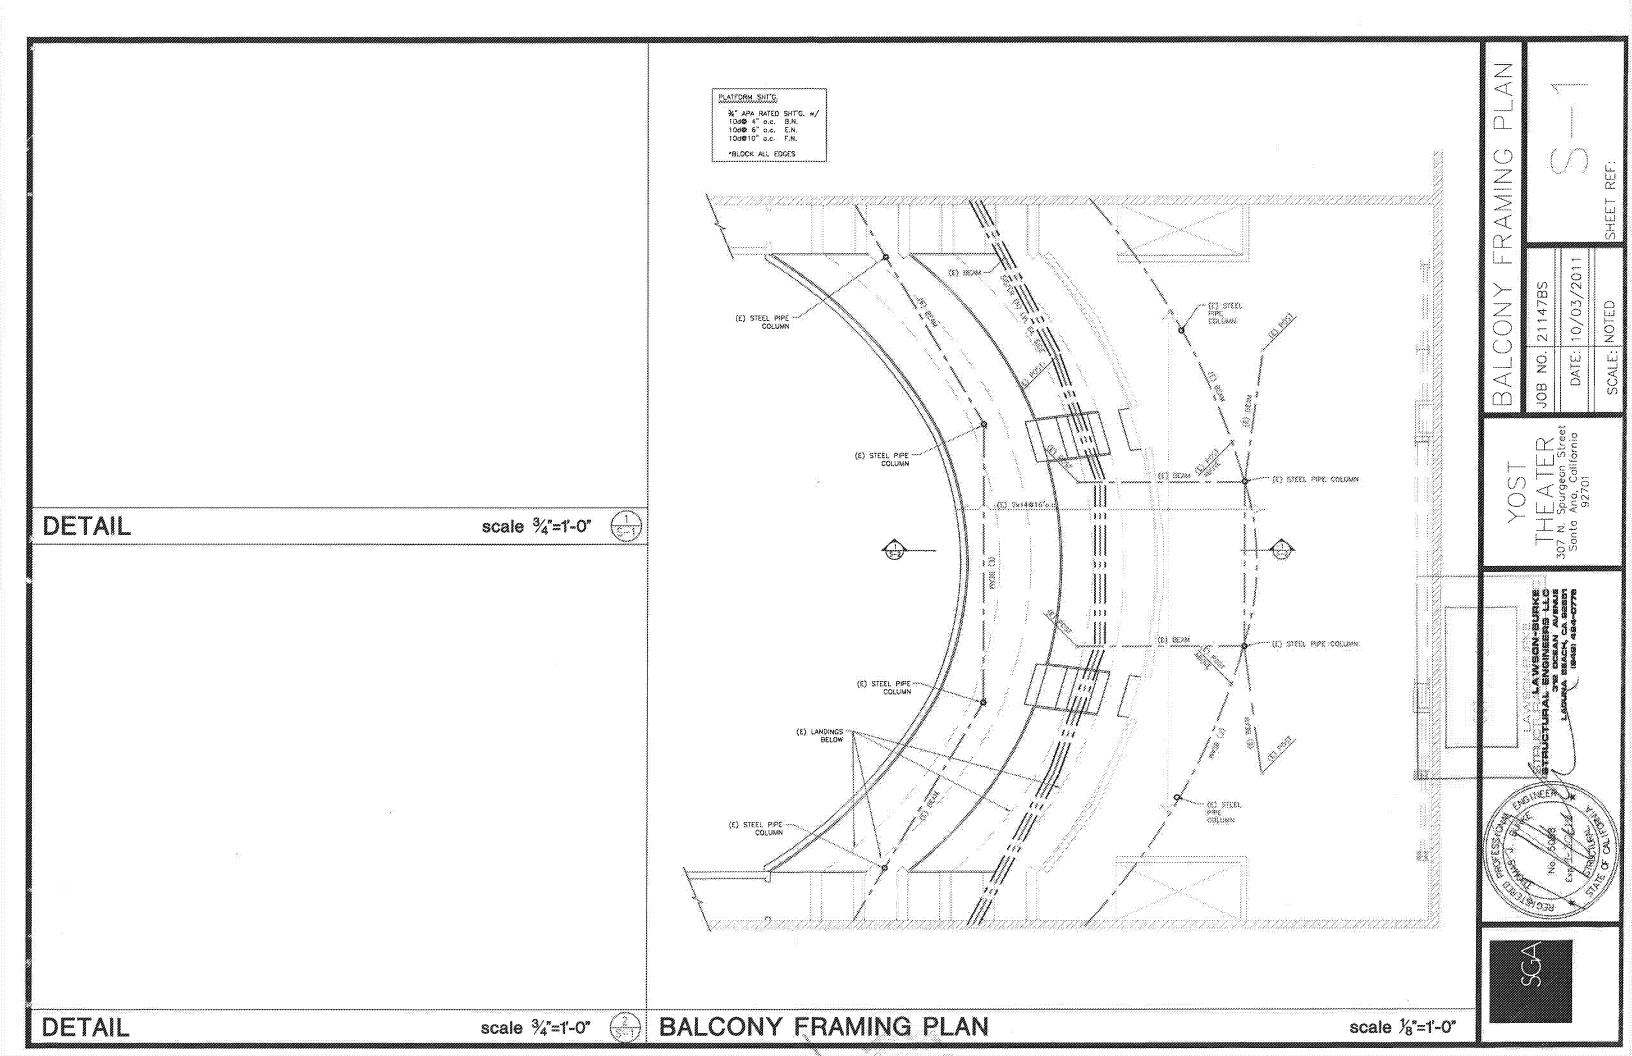Project Address: 397 N Sparges Suite#
New Plan Check No. 10173939
Original Plan Check No.: 1017339ゲ Permit Issuance Date: ルタ
Original Plan Checker: Zac Mazari
Amount paid: \$ 20725 Misc. Receipt #: 58524
Processed by: Hexnandor Date: 12-14-11
Plan Checker Approval: Date:
Additional Hours: @ \$207.25 = \$
Print Name: Denais Luy Signature:
Representing: Ritz and Yest True 152 A DVD
Telephone: (310) 493-2050 FAX: (714) 667 0174
Contact Person: Vennis Lay Telephone: (34) 493-2050
E-Mail: dennis, Lly @ gmail. com
PLANS PREPARED BY AN ARCHITECT OR ENGINEER MUST BE SIGNED BY THE PROFESSIONAL WHO PREPARES THEM.
PLEASE WRITE A BRIEF DESCRIPTION OF THE REVISION/SUPPLEMENT AND IF POSSIBLE AREA OF WORK. ALL REVISIONS ARE TO BE CLOUDED AND PROPERLY IDENTIFIED: (i.e. Deltas, Sheet Nos., etc).
Electrical, Plumbing and/or Mechanical plans – stamped job set shall accompany revised
plans. Remving unnealed asserva in belong

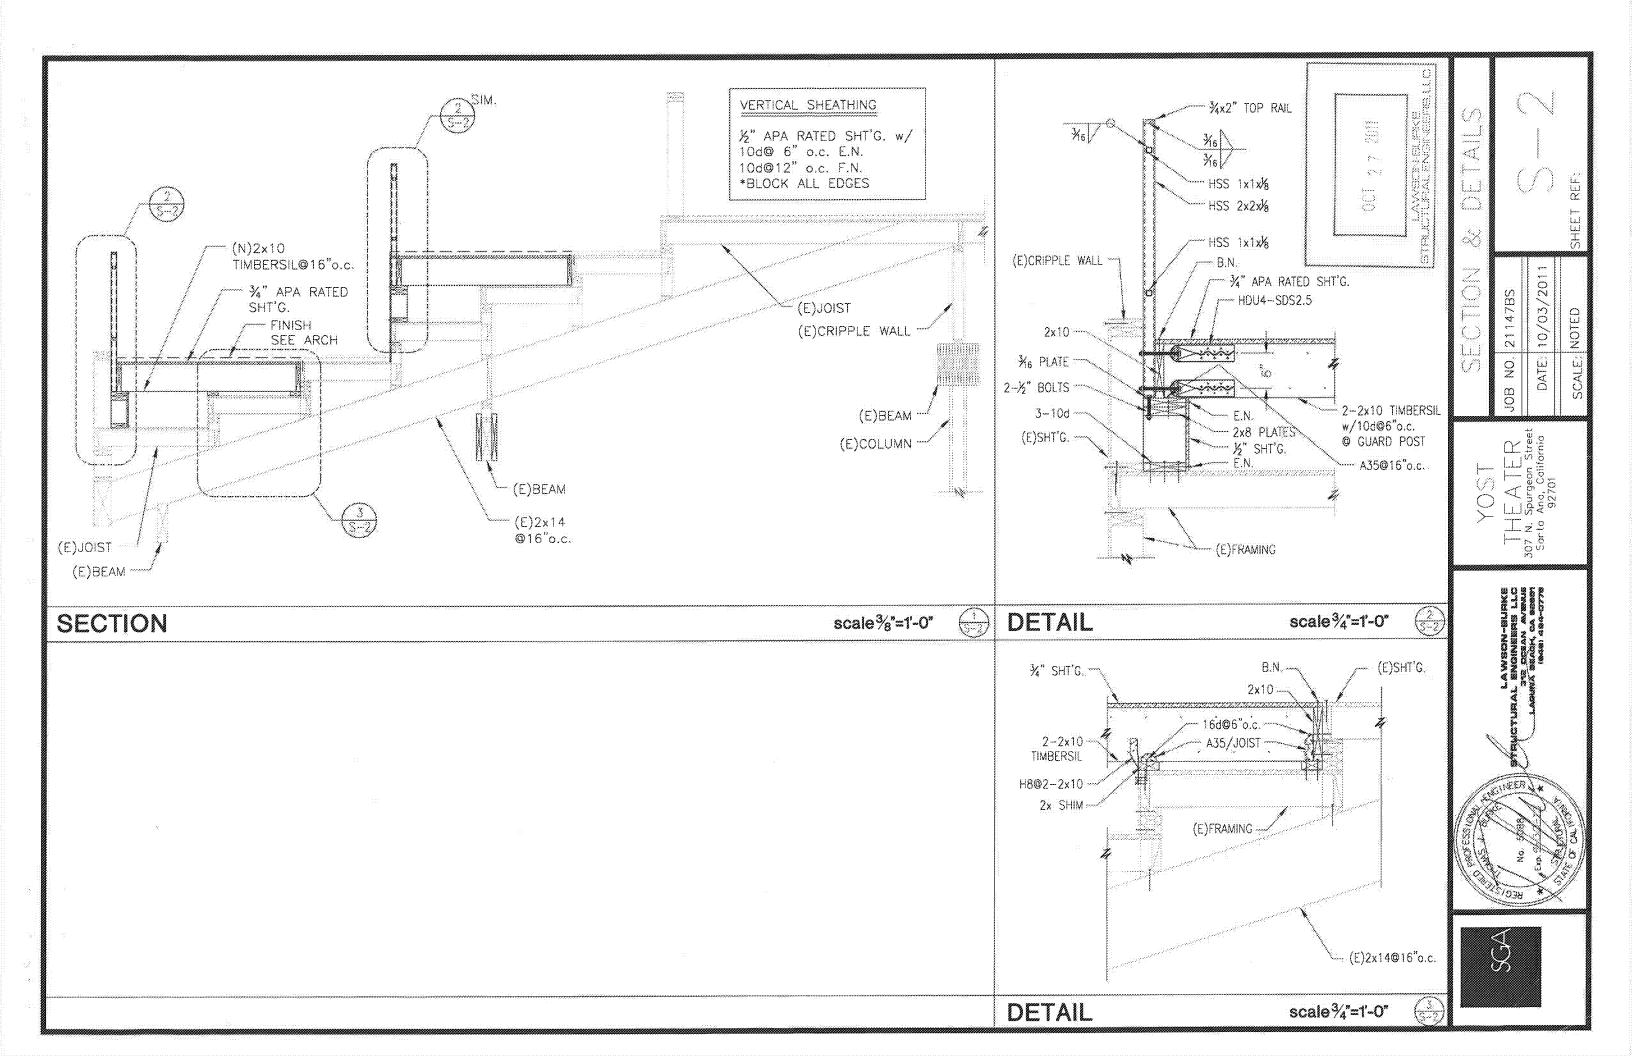

RADIANT BARRIER @ ROOF YES NO

RESIDENTIAL DEV. FEE YES NO



STEVEN GAFFNEY ARCHITECTURE INC

305 WEST FOURTH STREET SANTA ANA CA 92701 www.SGaffneyArch.com **TEL.** 714.571.0500 **FAX**: 714.571.0600

YOST **THEATER**

TENANT IMPROVEMENTS

307 N. Spurgeon Street Santa Ana, California

The stamping of this set of plans SHALL NOT be held to permit or to approve the violation of any law, or structural stability of any building. APPROVED 12-13-16

SCHEDULE FIRE DEPARTMENT INSPECTIONS AND TESTS 72 HOURS IN ADVANCE. PHONE (714) 647-5700 Morr T.D




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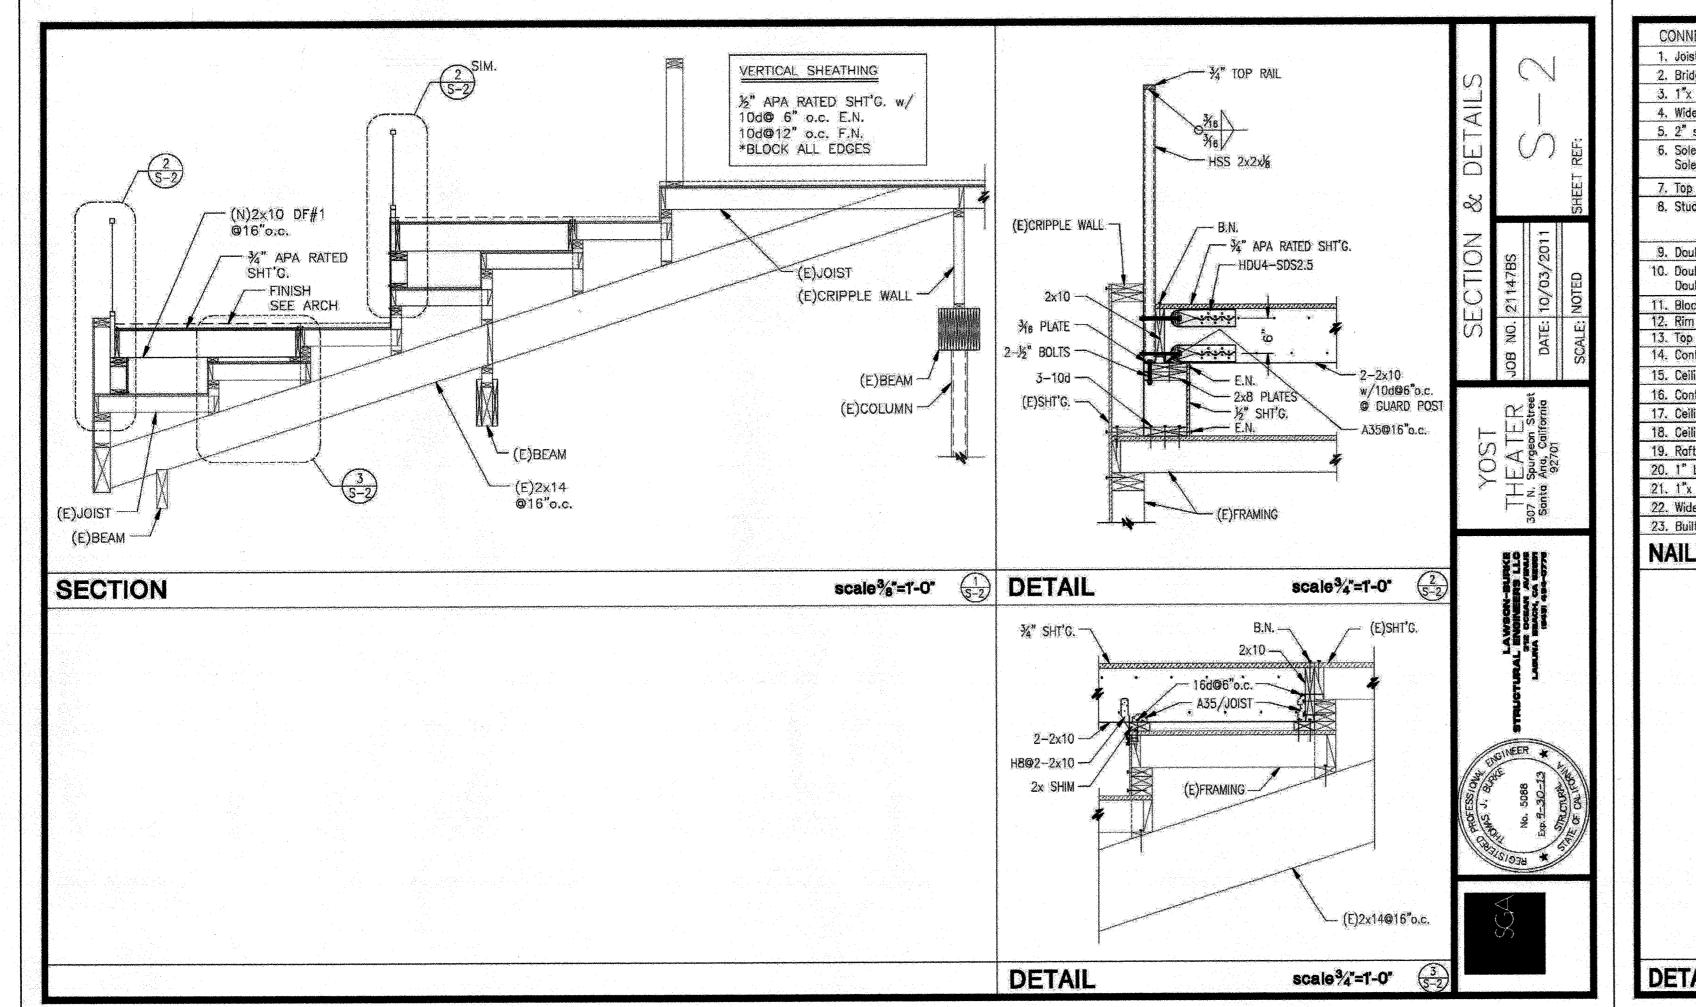
MEZZANINE PLATFORM REVISION

SHEET NUMBER

JOB NUMBER DATE SCALE

SK-AS NOTED



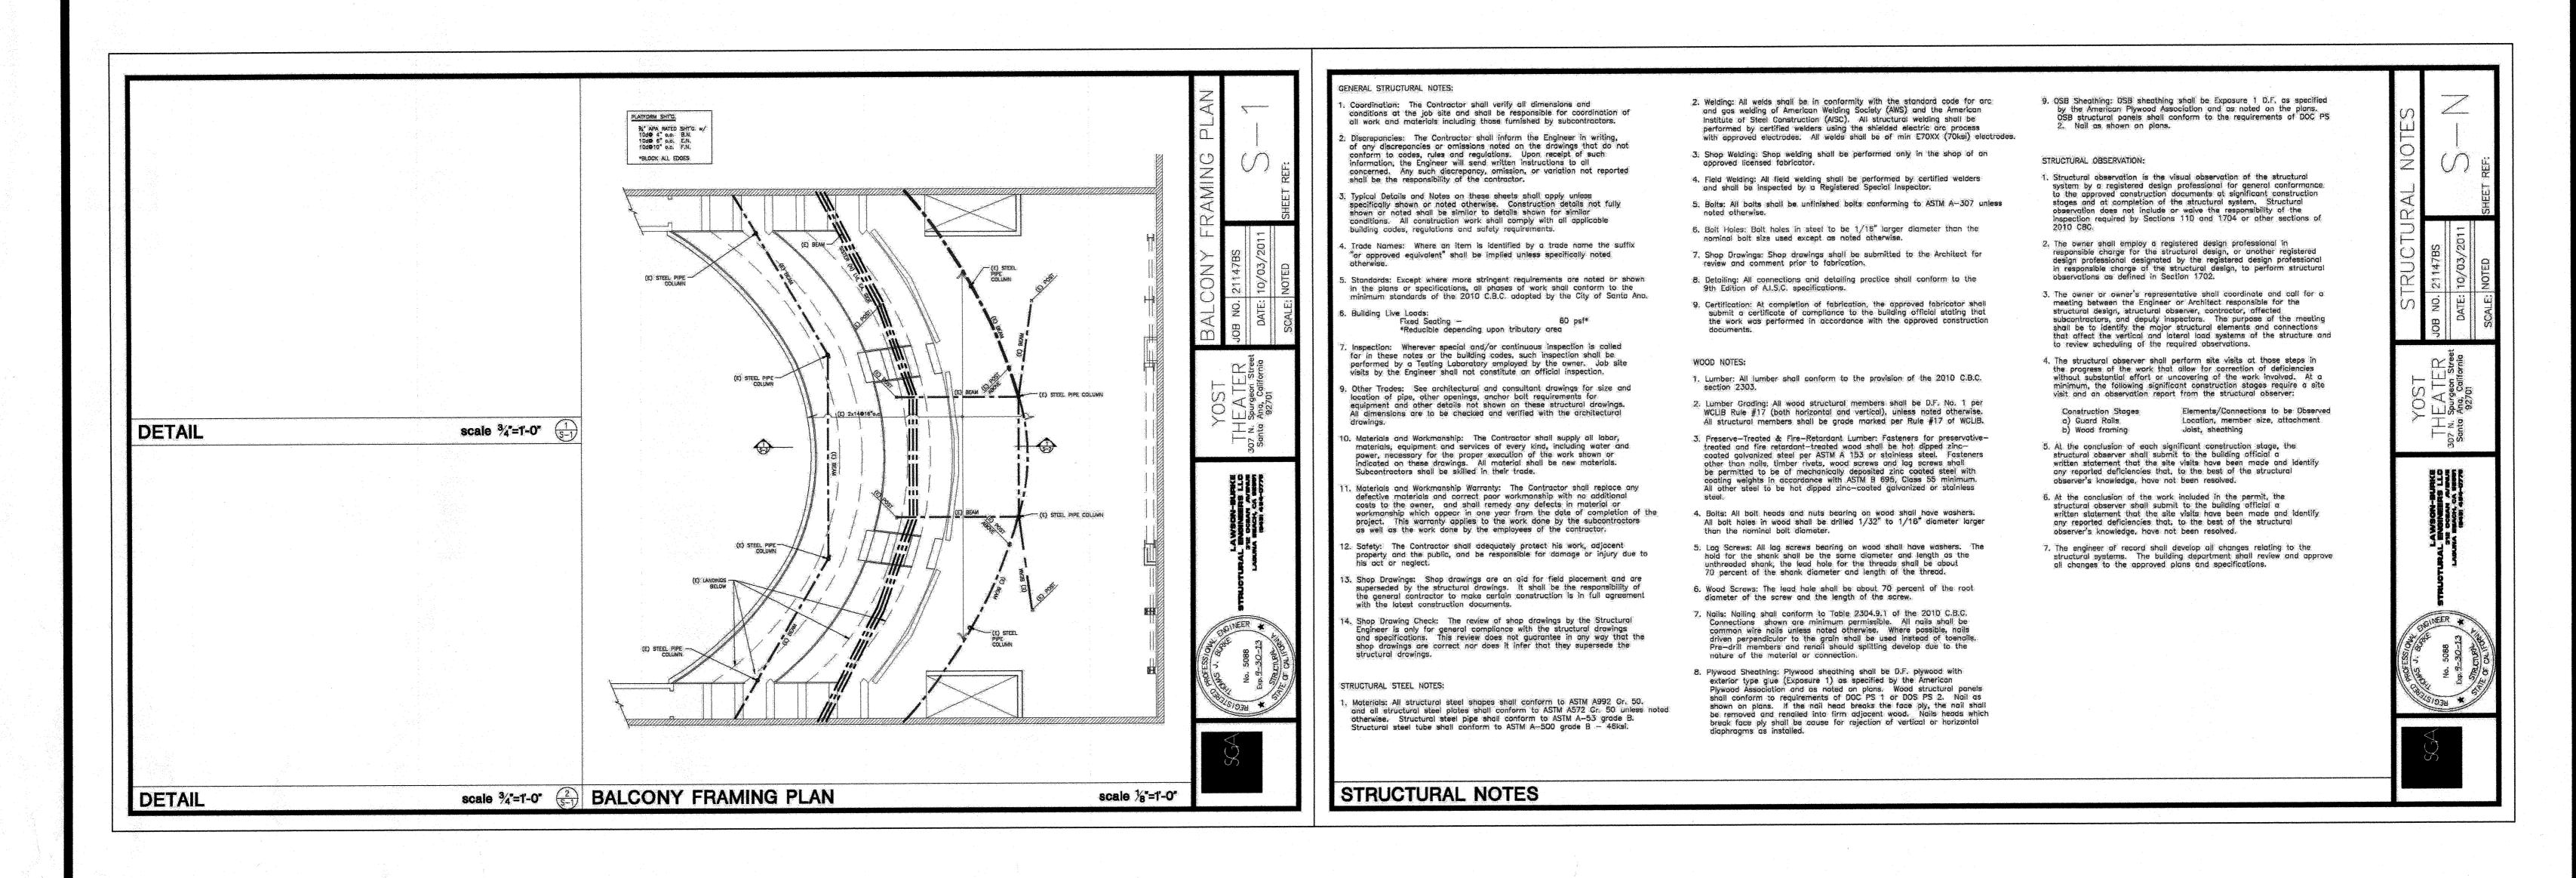

	er en							
CONNECTION	NAILING	LOCATION						
1, Joist to sill or girder	3-8d	toenail						
2. Bridging to joist	2-8d	toenail each end						
3. 1"x 6" subfloor or less to each joist	2-8d	face nail	Paragraphic Paragr					SO I
4. Wider than 1"x 6" subfloor to each joist	3-8d	face nail						
5. 2" subfloor to joist or girder .	2-16d	blind and face nai						
	16d @ 16°o,c.	typical face nail	-					
Sole plate to joist or blocking Sole plate to joist or blocking at braced wall panels	3-16d per 16"	braced wall panels						
7. Top plate to stud ·	2-16d	end nail						SHEET
8. Stud to sole plate	4-8d 2-16d	toenail						
	2-16d	end noil						
3x sole plate	2-20d	end nail						(S) 5
9. Double studs	16d @ 24"o.c.	face nail						TYPICA 2114788 10/03/2011 NOTED
10. Doubled top plates Doubled top plates	16d @ 16"o.c. 8-16d	typical face noil lap splice						(3)/28 (3)/28
11. Blocking between joists or rafters to top plate	3–8d	toenail		And the second s				TYP 21147 10/03, NOTED
12. Rim Joist to top plate	16d @ 6"o.c.	toenail						
13. Top plates, lops and intersections	2-16d	face nail						DATE:
14. Continuous header, two pieces	16d @ 16"o.c.	along each edge	•					BO CO SS
15. Ceiling joists to plate	3-8d	toenail	- Sylvania de la companya de la comp					15 1
16. Continuous header to stud	4-8d	toenail	age of the second of the secon					***
17. Ceiling joists, laps over partitions	3-16d min	face nail						C X g
18. Ceiling joists to parallel rafters	3-16d min	face nail						
19. Rafter to plate	3-8d	toenail						N Ties
20. 1" brace to each stud and plate	2-8d	face nail						YOST THEATER 307 N. Spurgeon Street Sonta Ang, California 92701
21. 1"x 8" sheathing or less to each bearing	3-8d	face nail						→ 三
22. Wider than 1"x 8" sheathing to each bearing	3-8d	face nail						H-5.5
23. Built-up corner studs	16d @ 24°o.c.							
	4	(1)	DETAIL				scale $\frac{3}{4}$ "=1'-0" $\frac{2}{5}$	
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STEVEN GAFFNEY
ARCHITECTURE INC

305 WEST FOURTH STREET SANTA ANA CA 92701 www.SGaffneyArch.com

TEL. 714.571.0500 **FAX**: 714.571.0600

YOST THEATER

TENANT IMPROVEMENTS

307 N. Spurgeon Street Santa Ana, California

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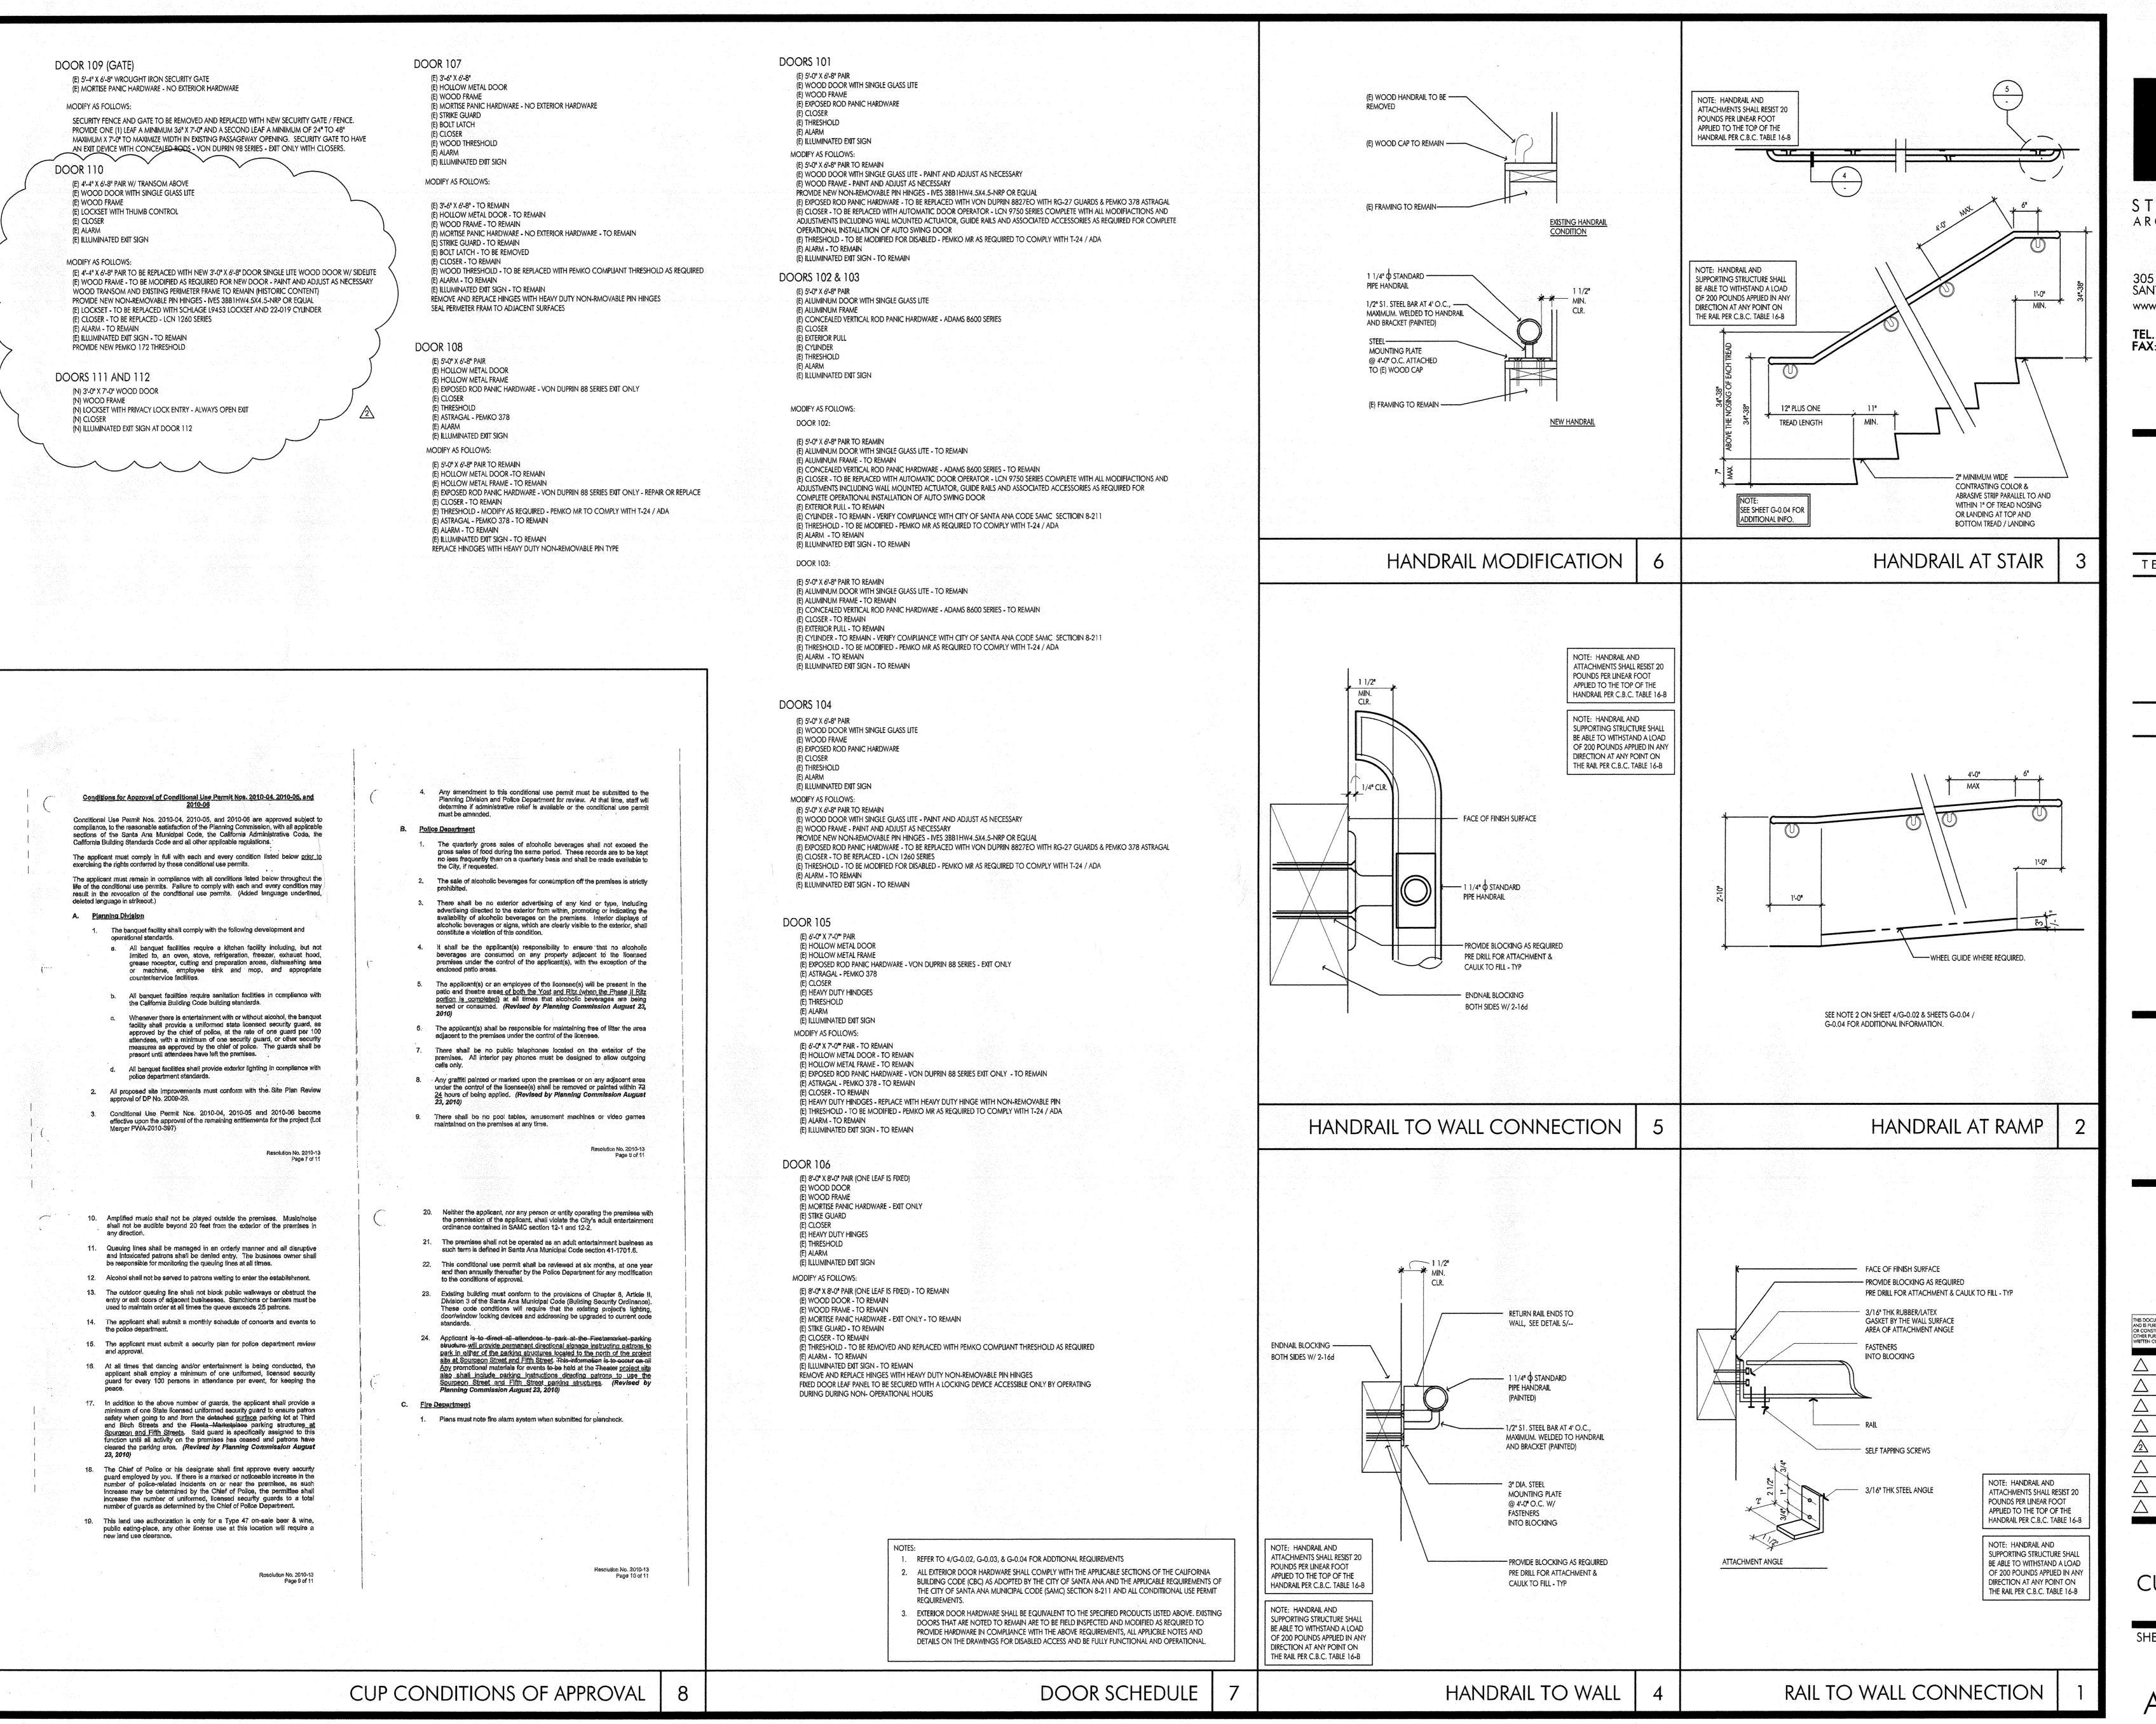
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MEZZANINE PLATFORM REVISION

SHEET NUMBER JOB NUMB

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STEVEN GAFFNEY ARCHITECTURE INC


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TEL. 714.571.0500 **FAX**: 714.571.0600

YOST THEATER

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11-16-11

DETAILS DOOR SCHED CUP CONDITIONS

SHEET NUMBER JOB NUMBER

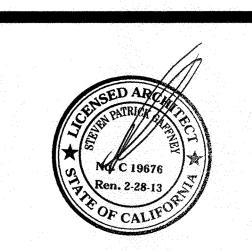DATE



STATE LICENSE NO. 471687 "Established 1980"

December 5, 2011

Mr. Kevin Jeffries Yost Theater 307 Spurgeon Street Santa Ana, CA 92701

Re: Fire Sprinkler Coverage

Kevin:


On 8/16/11 our field superintendent Allen Parza did a field survey of your automatic fire sprinkler system, to determine if the attic space between the kitchen ceiling and balcony area had proper fire sprinkler coverage. After his survey he determined that there was proper coverage as per NFPA 13, state and local codes.


If you have any questions or need any further information please give me a call at (909) 622-8911. I will be happy to assist you.

Regards

Pete Rosell
Vice President

Inland Empire Fire and Safety, Inc.

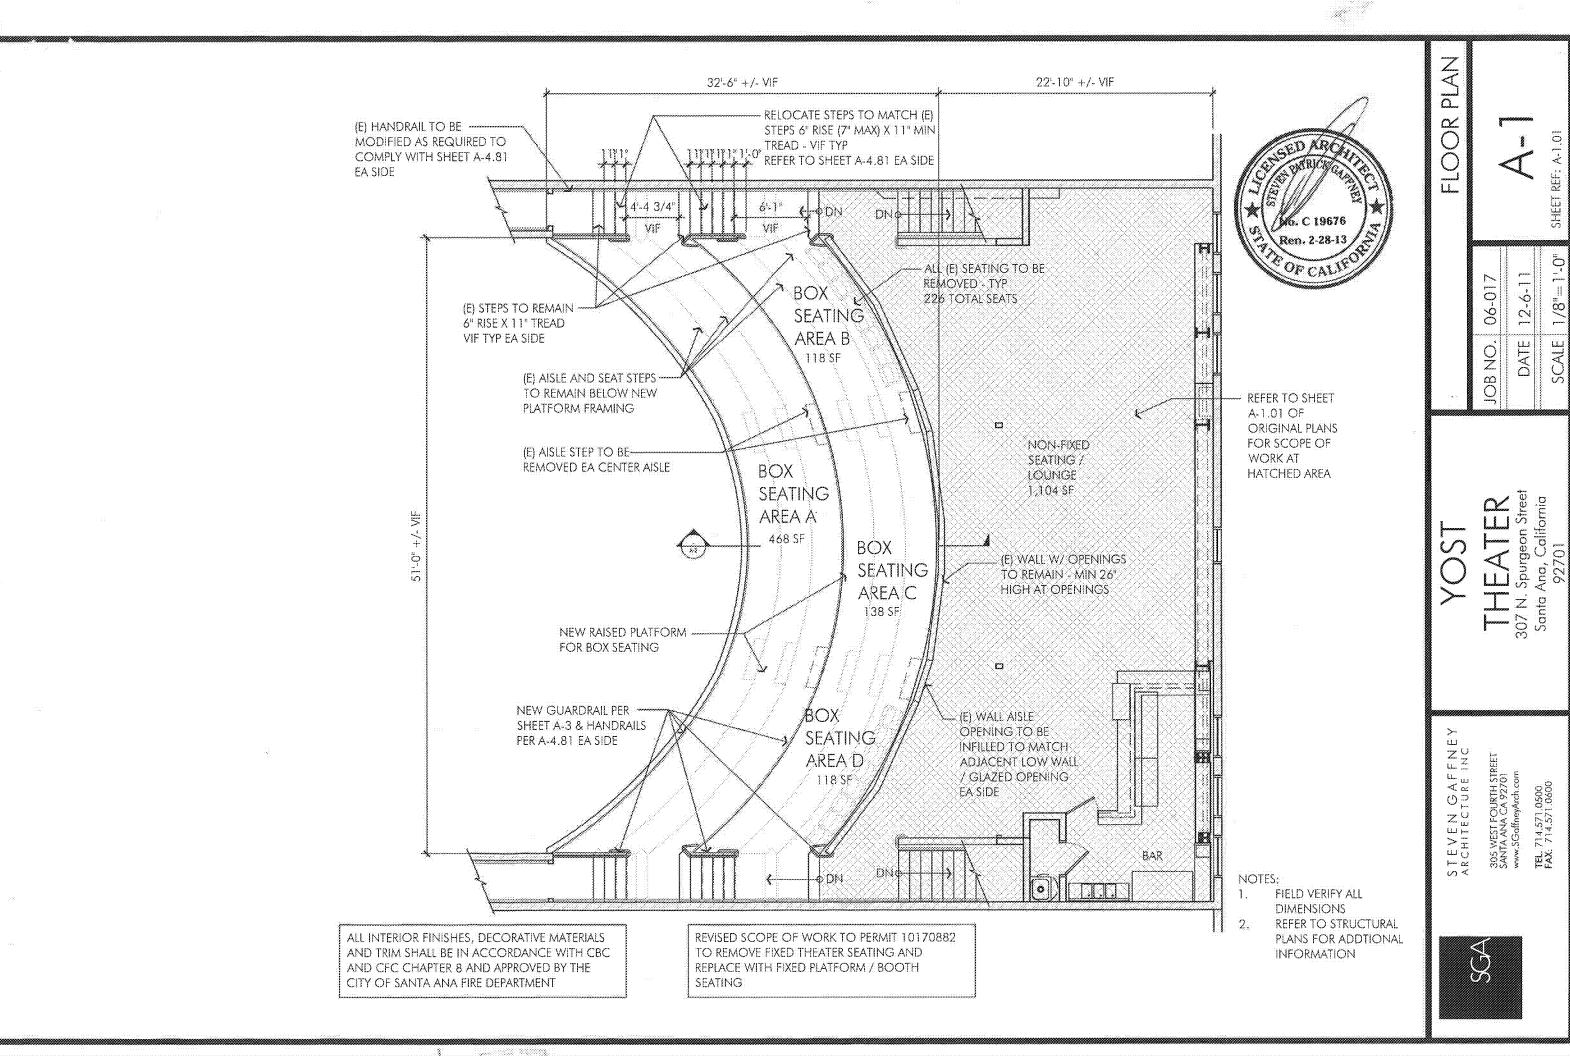

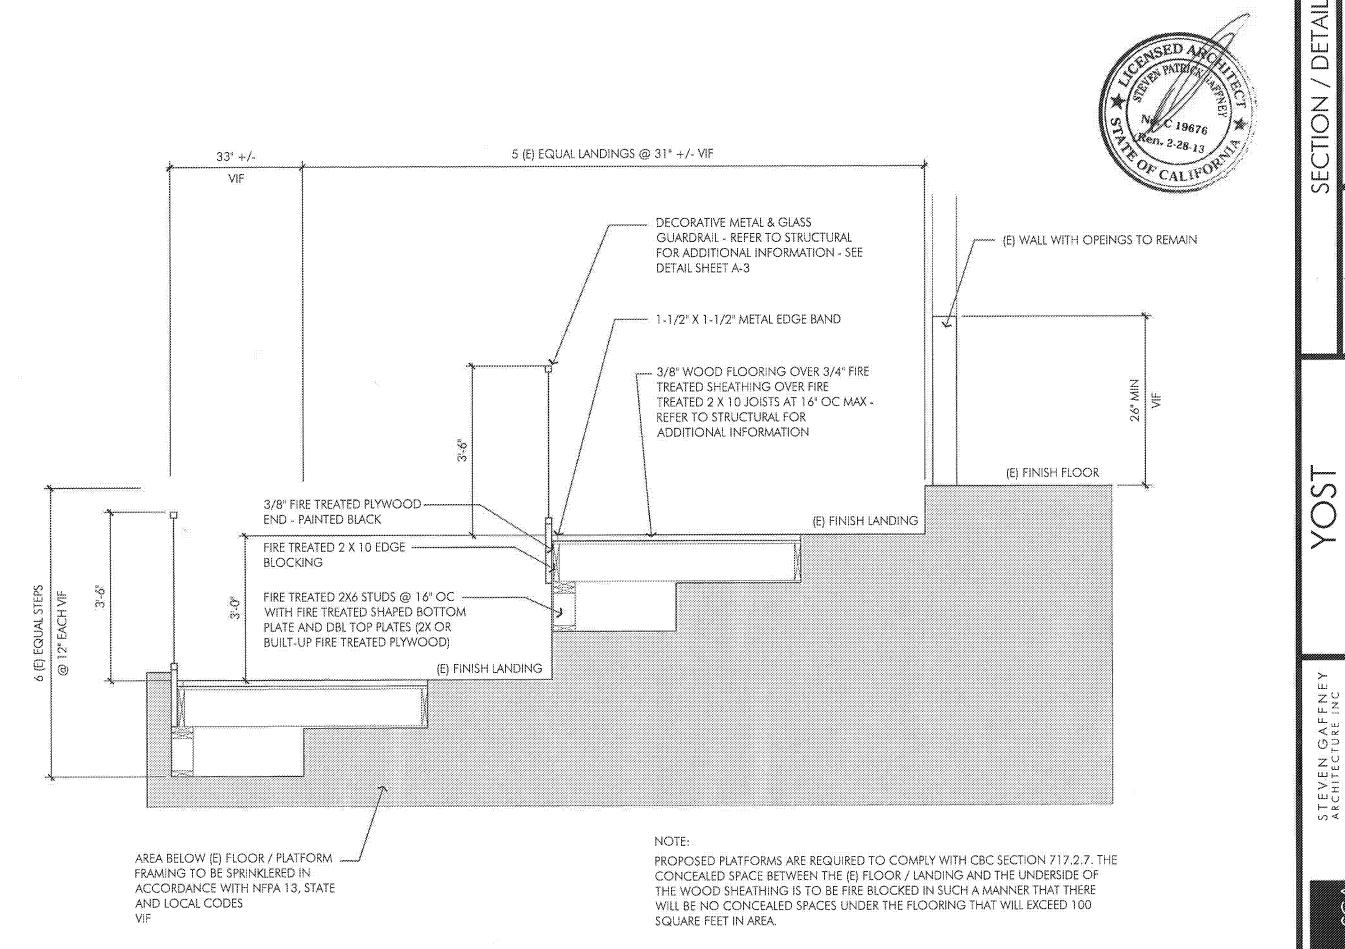

307 N. Spurgeon Street Santa Ana, California 92701


12-6-11

06-017

JOB NO

305 WEST FOURTH STREET SANTA ANA CA 92701 www.SGalfneyArch.com

TEL 714.571.0500 FAX: 714.571.0600

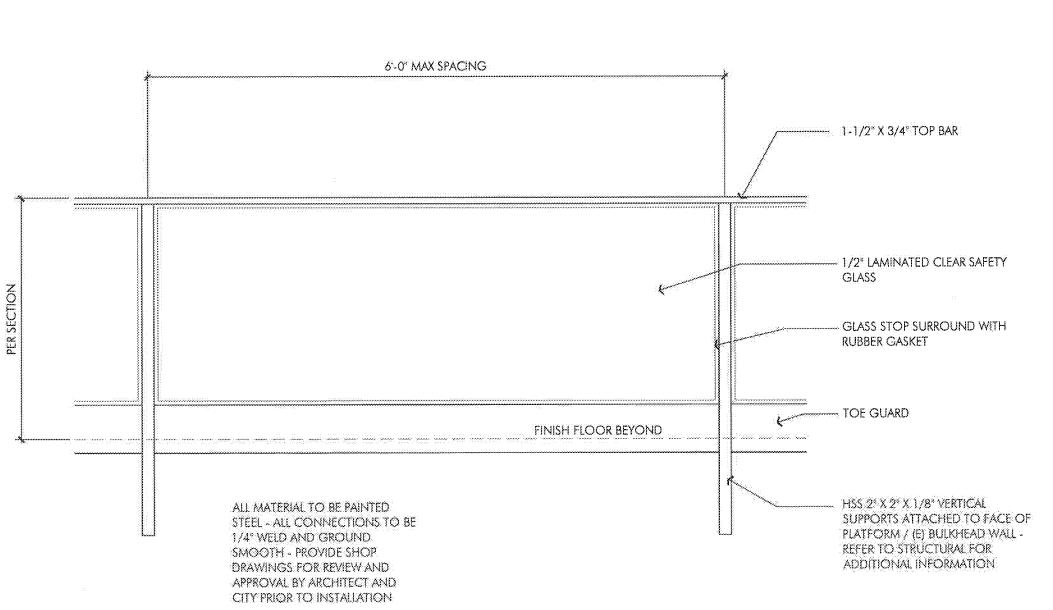

RAIL DETAIL

STEVEN GAFFNEY ARCHITECTURE INC 305 WEST FOURTH STREET SANTA ANA CA 92701 www.SGaffneyArch.com

TEL 714.571.0500 FAX: 714.571.0600

THEATER
307 N. Spurgeon Street
Santa Ana, California
92701

12-6-11

DATE

SCALE

06-017

JOB NO.

MEZZANINE LOUNGE OCCUPANT LOADS:

> MAXIMUM OCCUPANTS WITH NO SEATING OR STAGE 1,104 SF / 5 = 220 MAXIMUM **OCCUPANTS**

MAXIMUM OCCUPANTS WITH STAGE AND STANDING OCCUPANTS (NO BENCH SEATS) 998 SF / 5 + DJ'S = 201 MAXIMUM OCCUPANTS

MAXIMUM OCCUPANTS WITH BENCH SEATING AND STAGE 8-OCCUPANTS / BENCH + OCCUPANTS STANDING + DJ'S = 124 MAXIMUM OCCUPANTS

MOVABLE BENCH SEATING & TABLES AT LOUNGE AREA TYPICAL

WHEN PLACING FURNITURE DO NOT BLOCK EXIT PATH -MAINTAIN A MINIMUM 44" PATH OF TRAVEL TO STAIRS - TYPICAL

POSTED MEZZANINE MAXIMUM OCCUPANT LOADS:

> NO SEATING OR STAGE AT LOUNGE = 302 MAXIMUM **OCCUPANTS**

NO SEATING WITH STAGE AT LOUNGE = 283 MAXIMUM **OCCUPANTS**

SEATING WITH STAGE AT LOUNGE = 206 MAXIMUM OCCUPANTS



OCCUPANCY PLAN

FURNITURE

12-6-11 06-017 JOB NO. DATE

SCALE

REF: A-1.01

SHEET

307 N. Spurgeon Street Santa Ana, California 92701

STEVEN GAFFNEY ARCHITECTURE INC 305 WEST FOURTH STREET SANTA ANA CA 92701 www.SGdffnouArch

FAX: 714.571.0500

GENERAL STRUCTURAL NOTES:

- Coordination: The Contractor shall verify all dimensions and conditions at the job site and shall be responsible for coordination of all work and materials including those furnished by subcontractors.
- 2. Discrepancies: The Contractor shall inform the Engineer in writing, of any discrepancies or amissions nated on the drawings that do not conform to codes, rules and regulations. Upon receipt of such information, the Engineer will send written instructions to all concerned. Any such discrepancy, amission, or variation not reported shall be the responsibility of the contractor.
- 3. Typical Details and Notes on these sheets shall apply unless specifically shown or noted otherwise. Construction details not fully shown or noted shall be similar to details shown for similar conditions. All construction work shall comply with all applicable building codes, regulations and safety requirements.
- Trade Names: Where on item is identified by a trade name the suffix "or approved equivalent" shall be implied unless specifically nated atherwise.
- 5. Standards: Except where more stringent requirements are noted or shown in the plans or specifications, all phases of work shall conform to the minimum standards of the 2010 C.B.C. adopted by the City of Santa Ana.
- Building Live Loads:
 Fixed Seating -- 60 psf*
 *Reducible depending upon tributary area
- 7. Inspection: Wherever special and/or continuous inspection is called for in these nates or the building codes, such inspection shall be performed by a Testing Laboratory employed by the owner. Job site visits by the Engineer shall not constitute an official inspection.
- 9. Other Trades: See architectural and consultant drawings for size and location of pipe, other openings, anchor bolt requirements for equipment and other details not shown on these structural drawings.

 All dimensions are to be checked and verified with the architectural drawings.
- 10. Materials and Workmanship: The Contractor shall supply all labor, materials, equipment and services of every kind, including water and power, necessary for the proper execution of the work shown or indicated on these drawings. All material shall be new materials. Subcontractors shall be skilled in their trade.
- 11. Materials and Workmanship Warranty: The Contractor shall replace any defective metericls and correct poor workmanship with no additional costs to the owner, and shall remedy any defects in material or workmanship which appear in one year from the date of completion of the project. This warranty applies to the work done by the subcontractors as sell as the work done by the employees of the contractor.
- 12. Safety: The Contractor shall adequately protect his work, adjusent property and the public, and be responsible for damage or injury due to his act or neglect.
- 13. Shop Grawings: Shop drawings are an aid for field placement and are superseded by the structural drawings. It shall be the responsibility of the general contractor to make certain construction is in full agreement with the latest construction documents.
- 14. Shop Browing Check: The review of shop drawings by the Structural Engineer is only for general compliance with the structural drawings and specifications. This review does not guarantee in any way that the shop drawings are correct nor does it inter that they supersede the structural drawings.

STRUCTURAL STEEL NOTES:

Materials: All structural steel shapes shall conform to ASTM A992 Gr. 50.
 and all structural steel plates shall conform to ASTM A572 Gr. 50 unless noted
 otherwise. Structural steel pipe shall conform to ASTM A-53 grade 8.
 Structural steel tube shall conform to ASTM A-500 grade B - 46ksi.

- 2. Weisling: All welds shall be in conformity with the standard code for are and gas weisling of American Weisling Society (AWS) and the American Institute of Steel Construction (AISC). All structural weisling shall be performed by certified welders using the shielded electric arc process with approved electrodes. All welds shall be of min E70XX (70ks) electrodes.
- Shop Welding: Shop welding shall be performed only in the shop of an approved licensed tobricator.
- 4. Field Welding: All field welding shall be performed by certified welders and shall be inspected by a Registered Special Inspector.
- Bests: All bolts shall be unfinished botts conforming to ASIM A-307 unless noted otherwise.
- 6, Bolt Hoies: Bolt holes in steel to be 1/16" larger diameter than the nominal bolt size used except as noted otherwise.
- Shop Drawings: Shop drawings shall be submitted to the Architect for review and comment prior to fabrication.
- 8. Detailing: All connections and detailing practice shall conform to the 9th Edition of A.I.S.C. specifications.
- Certification: At completion of fabrication, the approved fabricator shall submit a certificate of compliance to the building official stating that the work was performed in accordance with the approved construction documents.

WOOD NOTES:

- Lumber: All lumber shall conform to the provision of the 2010 C.B.C. section 2303.
- Lumber Grading: All wood structural members shall be D.F. No. 1 per WCLIB Rule #17 (both harizontal and vertical), unless noted otherwise.
 All structural members shall be grade marked per Rule #17 of WCLIB.
- 3. Preserve—Treated & Fire—Retardant Lumber: Fosteners for preservative—treated and fire retardant—treated wood shall be not dipped ziec—coated galvanized steel per ASTM A 153 or stainless steel. Easteners other than noise, timber rivets, wood screws and log screws shall be permitted to be at mechanically deposited zinc coated steel with coating weights in occerdance with ASTM 8 695, Class 55 minimum. All other steel to be hot dipped zinc—coated galvaraged or stainless steel.
- 4. Boits: All bolt heads and nuts bearing on wood shall have washers. All bolt holes in wood shall be drilled 1/32" to 1/16" diameter larger than the nominal bolt diameter.
- 5. Lag Saress; All lag screws bearing on wood shall have washers. The hold for the shank shall be the same diameter and length as the unthreaded shark, the lead hale for the threads shall be about 70 percent of the shank diameter and length of the thread.
- Wood Screws: The lead hole shall be about 70 percent of the root diameter of the screw and the length of the screw.
- 7. Nails: Nailing shall conform to Table 2004.6.1 of the 2010 C.B.C. Connections shown are minimum permissible. All nails shall be common wire nails unless nated atherwise. Where possible, nails driven perpendicular to the grain shall be used instead of toenails. Pre-drill members and renail should splitting develop due to the nature of the material or connection.
- 8. Plywood Sheathing: Plywood sheathing shall be D.F. plywood with exterior type glue (Exposure 1) as specified by the American Plywood Association and as noted on plans. Wood structural panels shall conform to requirements of DOC PS 1 or DOS PS 2. Notices shown on plans. If the notice head brooks the face ply, the notice shall be removed and renailed into firm adjacent wood. Notice heads which break face ply shall be course for rejection of vertical or harizontal diaphrogras as installed.

 OSB Sheathing: OSB sheathing shall be Exposure 1 D.F. as specified by the American Plywood Association and as noted on the plans. OSB structural panels shall conform to the requirements of DOC PS 2. Nail as shown on plans.

TimberSil Notes

- TimberSil framing members, made with kiln dried Southern Yellow Pine No 1, or a better grade of Southern Yellow Pine, is manufactured by TimberSil, Springfield, Virginia.
- 2. Allowable bending stress Fb = 2700 psi minimum. Modules of Elasticity E = 19,000,000 psi minimum
- 3. Grade/Manufacturers Stamp: Members shall be stamped and inspected per the manufacturer.


STRUCTURAL OBSERVATION:

- Structural abservation is the visual observation of the structural system by a registered design professional for general conformance to the approved construction documents at significant construction stages and at completion of the structural system. Structural observation does not include or waive the responsibility of the inspection required by Sections 110 and 1704 or other sections of 2010 CBC.
- 2. The owner shall employ a registered design professional in responsible charge for the structural design, or another registered design professional designated by the registered design professional in responsible charge of the structural design, to perform structural observations as defined in Section 1702.
- 3. The owner or owner's representative shall coordinate and call for a meeting between the Engineer or Architect responsible for the structural design, structural abserver, Contractor, affected subcontractors, and deputy inspectors. The purpose of the meeting shall be to identify the major structural elements and connections that affect the vertical and lateral load systems of the structure and to review scheduling of the required observations.
- 4. The structural observer shall perform site visits at those steps in the progress of the work that allow for correction of deficiencies without substantial effort or uncovering of the work lovalved. At a minimum, the following significant construction stages require a site visit and an observation report from the structural observer.

Construction Stages

a) Guard Rails b) Wood framing Elements/Connections to the Observed Location, member size, attrichment Joist, sheathing

- 5. At the conclusion of each significant construction stage, the structural observer shall submit to the building afficial a written statement that the site visits have been made and identify any reported deficiencies that, to the best of the structural observer's knowledge, have not been resolved.
- 6. At the conclusion of the work included in the permit, the structural observer shall submit to the building official a written statement that the site visits have been made and identify any reported deficiencies that, to the best of the structural observer's knowledge, have not been residued.
- 7. The engineer of record shall develop all changes relating to the structural systems. The building department shall review and approve all changes to the approved plans and specifications......

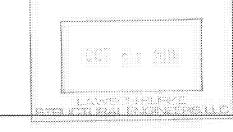

REF

SHEET

SCALE

JOB NO. 21147BS

10/03/201

DATE

YOST
THEATER
So7 N. Spurgeon Street
Santa Ana, California
92701

No Kin STRUCTURAL ENGINEERS I

SGA

			,,,,,,,,,,,		
CONNECTION	NAILING	LOCATION			
1. Joist to sill or girder	3-8d	toenail			
2. Bridging to joist	2-8d	toenail each end			
3. 1"x 6" subfloor or less to each joist.	2-8d	face nail			
4. Wider than 1"x 6" subfloor to each joist	3-8d	face noil			
5. 2" subfloor to joist or girder	216d	blind and face nail			
6. Sole plate to joist or blocking Sole plate to joist or blocking at braced wall panels	16d @ 16"o.c. 3-16d per 16"	typical face nail braced wall panels			
7. Top plate to stud	2-16d	end noil			
8. Stud to sole plate 3x sole plate	48d 216d 220d	toenail end nail end nail			
9. Double studs	16d @ 24"o.c.	face nail			
10. Doubled top plates Doubled top plates	16d @ 16"o.c. 8-16d	typical face nail lap splice			
11. Blocking between joists or rafters to top plate	38d	toenail			
12. Rim Joist to top plate	16d @ 5″o.c.	toenail			
13. Top plotes, laps and intersections	2-16d	face nail			
14. Continuous header, two pieces	16d @ 16"o.c.	along each edge			
15. Ceiling joists to plate	3-8d	toenail			
16. Continuous header to stud	4-8d	toenail			
17. Ceiling jaists, laps over partitions	3-16d min	face nail			
18. Ceiling joists to parallel rafters	3-16d min	face noil			
19. Rofter to plote	3-8d	toenail			
20. 1" brace to each stud and plate	2-8d	face noil			
21. 1"x 8" sheathing or less to each bearing	3-8d	face nail			
22. Wider than 1"x 8" sheathing to each bearing	3-8d	face nail			
23. Built-up corner studs	16d © 24″a.c.				
NAILING SCHEDULE					


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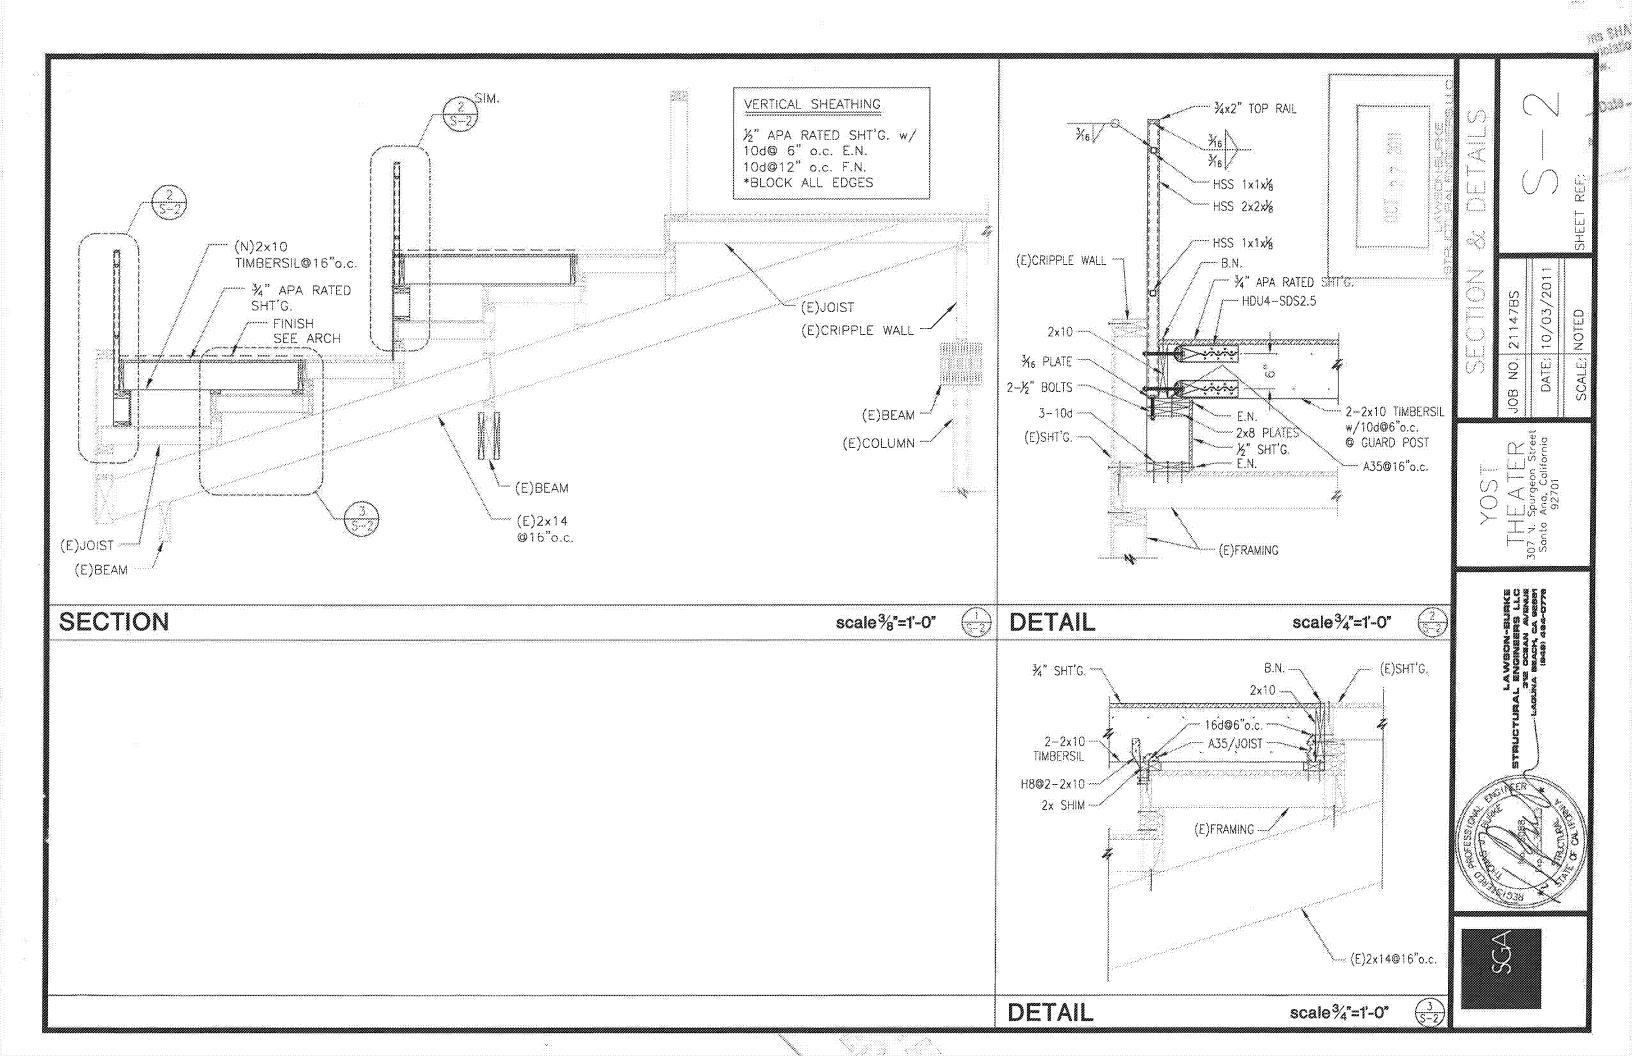
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Planning & Building Agency Building Safety Division 20 Civic Center Plaza P.O. Box 1988 (M-19) Santa Ana, CA 92702 (714) 647-5800 www.santa-ana.org

REVISION/SUPPLEMENTAL PLAN CHECK REQUEST


Project Address: 397 N Spryges	Suite#					
New Plan Check No. 10173939						
Original Plan Check No.: 10173394 Permit	Issuance Date:					
Original Plan Checker; Zac Mazari						
Amount paid: \$ 207 25 Misc. F	Receipt #: 5 85 2 4					
Processed by: Processed by: Date:	12-14-11					
Plan Checker Approval: July Date:	102 1921					
Additional Hours: @ \$20	7.25 = \$					
Print Name: Denais Luy Signature:						
Trepresenting.	<u> A gra</u>					
) 667 0174					
Contact Person: Sen NIS Lay Telephone	»: (31) <u>443-2050</u>					
E-Mail: dennis, Llny @ gmail.com						
PLANS PREPARED BY AN ARCHITECT OR ENGINEER MUST BE SIGNED BY THE PROFESSIONAL WHO PREPARES THEM.						
PLEASE WRITE A BRIEF DESCRIPTION OF THE REVISION/SUPPLEMENT AND IF POSSIBLE AREA OF WORK. ALL REVISIONS ARE TO BE CLOUDED AND PROPERLY IDENTIFIED: (i.e. Deltas, Sheet Nos., etc). Electrical, Plumbing and/or Mechanical plans – stamped job set shall accompany revised						
plans. Removing what of a life was a	b set snall accompany revised					




Planning & Building Agency Building Safety Division 20 Civic Center Plaza P.O. Box 1988 (M-19) Santa Ana, CA 92702 (714) 647-5800 www.santa-ana.org

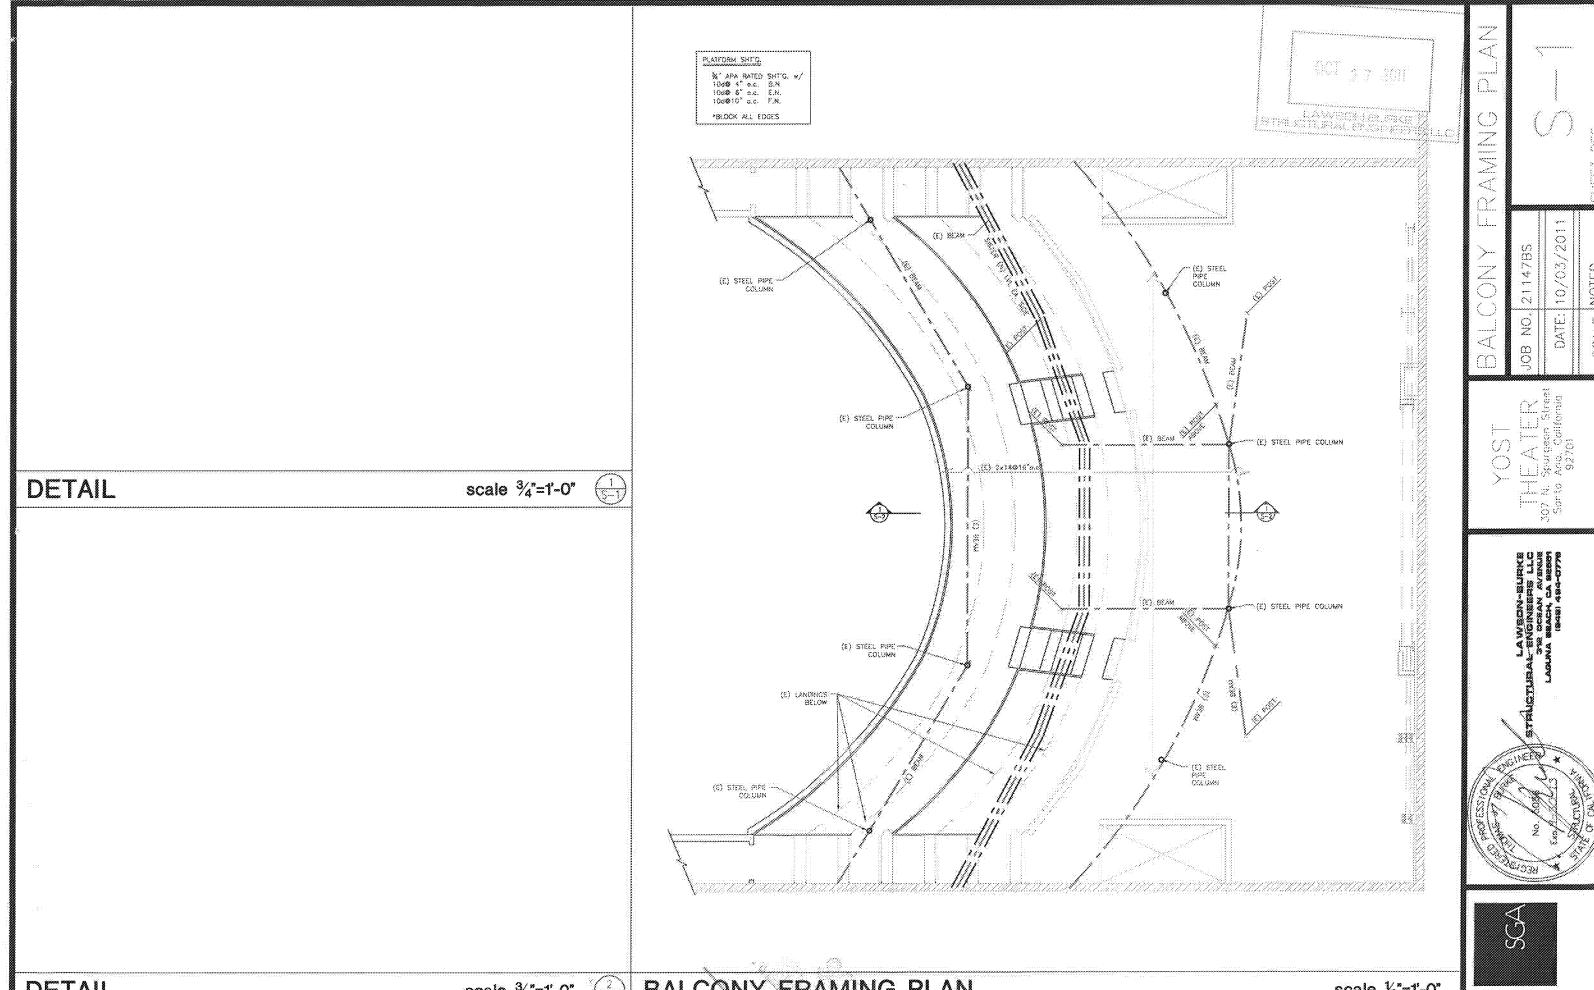REVISION/SUPPLEMENTAL PLAN CHECK REQUEST

Project Address: 397 N Sprgen Suite#
New Plan Check No. 10173939
Original Plan Check No.: 10173394 Permit Issuance Date: \sqrt{A}
Original Plan Checker: Zac Mazarii
Amount paid: \$ 20725 Misc. Receipt #: 58524
Processed by: Utexpander Date: 12-14-11
Plan Checker Approval: 160 Date: 14/19/1
Additional Hours: @ \$207.25 = \$
Print Name: Dennis Luy Signature: Representing: Ritz and Yest Too St A Drop Telephone: (310) 493-2050 FAX: (714) 667 017 4 Contact Person: Panis Luy G gmail. Com PLANS PREPARED BY AN ARCHITECT OR ENGINEER MUST BE SIGNED BY THE PROFESSIONAL WHO PREPARES THEM. PLEASE WRITE A BRIEF DESCRIPTION OF THE REVISION/SUPPLEMENT AND IF POSSIBLE AREA OF WORK. ALL REVISIONS ARE TO BE CLOUDED AND PROPERLY IDENTIFIED: (i.e. Deltas, Sheet Nos., etc). Electrical, Plumbing and/or Mechanical plans – stamped job set shall accompany revised plans. Removed united the state of the state o
The state of the s

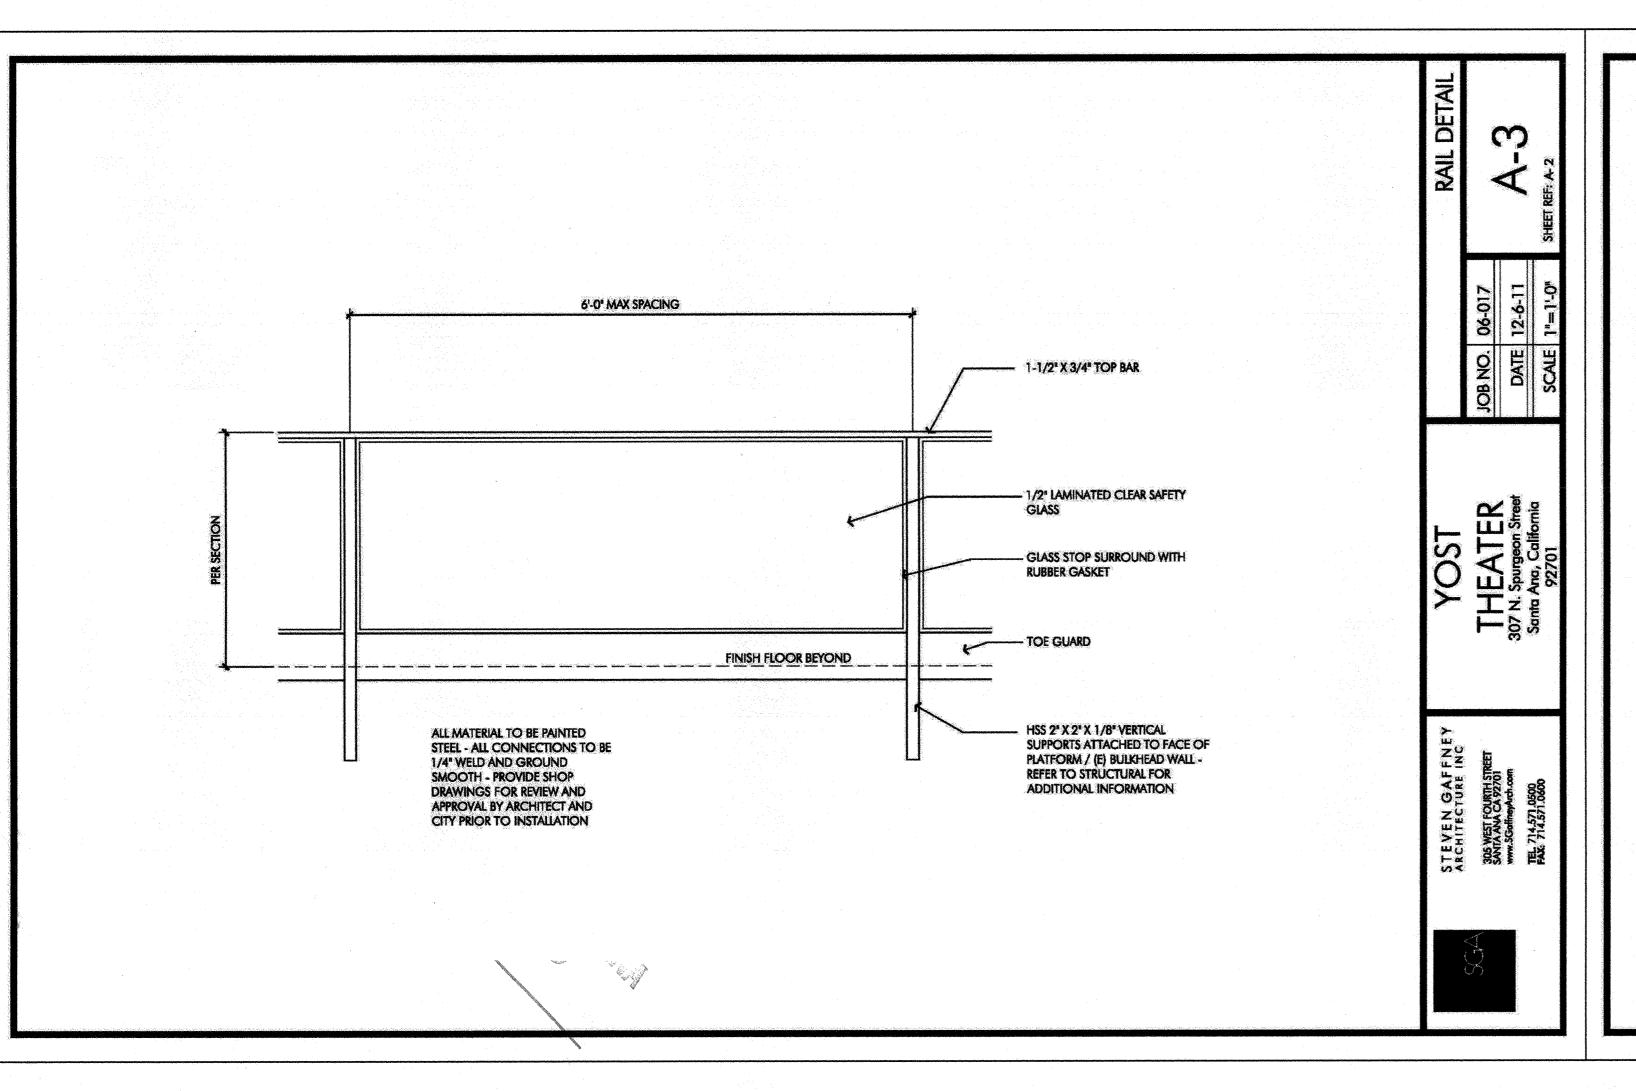

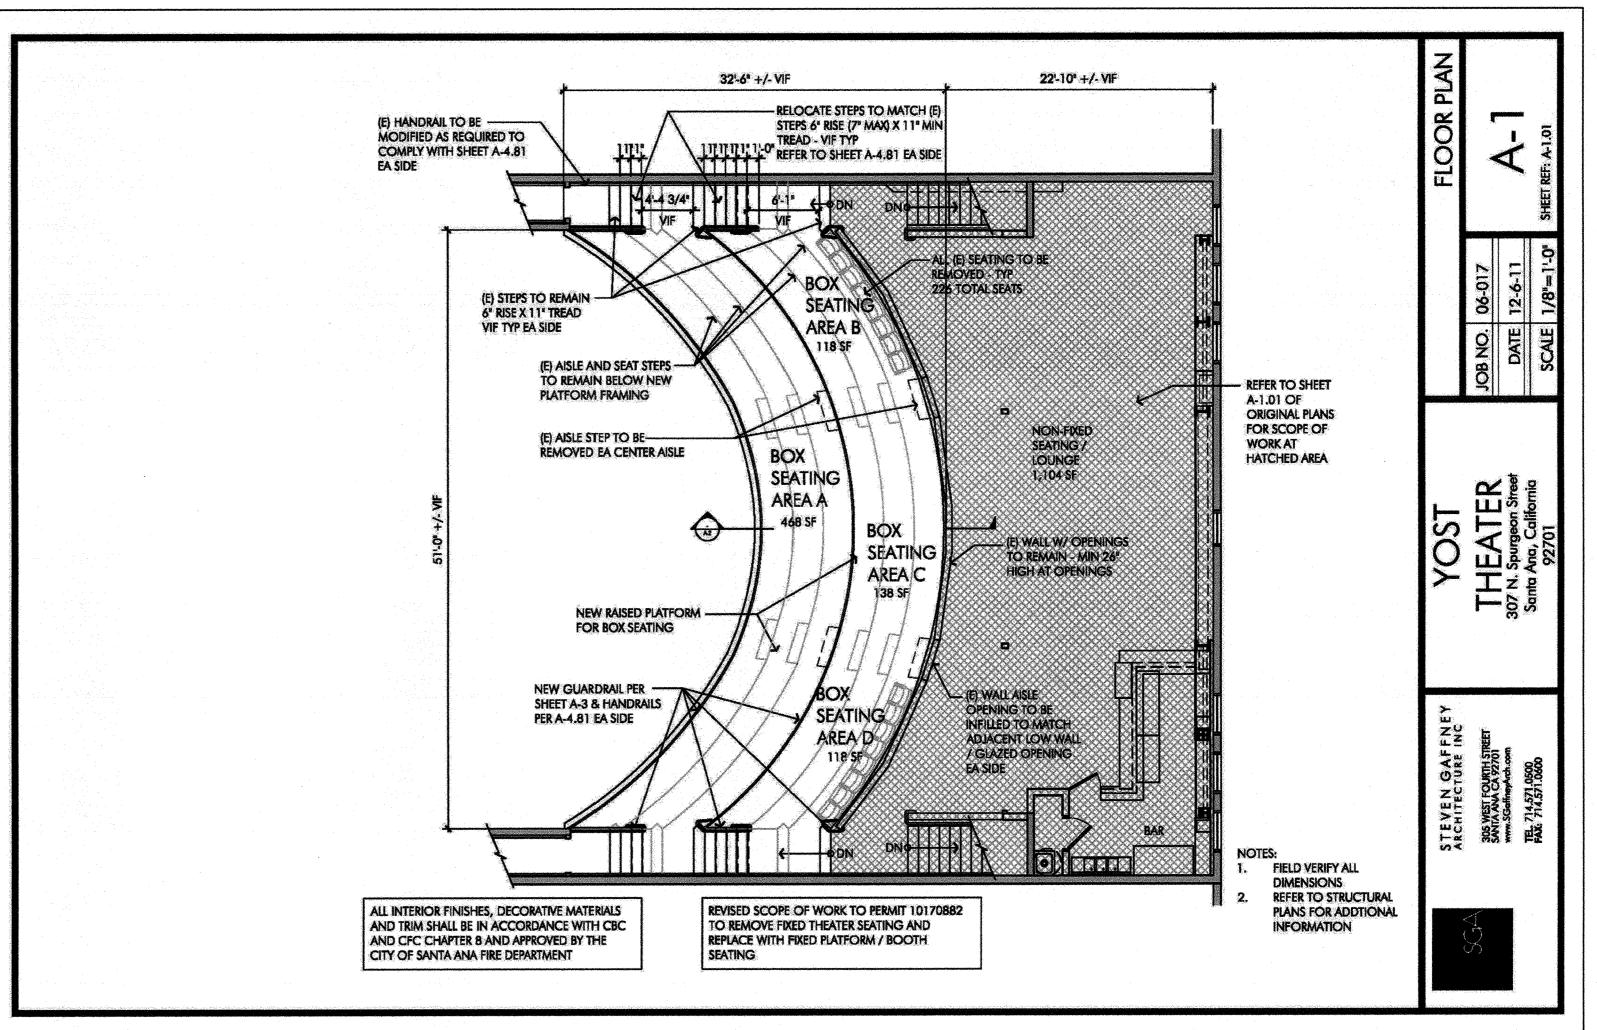

MELL CHAPLE LABOUT.

APPROVED SANTA ANA
POLICE DEPT.

POLICE FINAL INSPECTIO RECUIRED

APPROYED PLANNING DIVISION

> INSPECTIONS AND TESTS 72 HOURS IN ADVANCE. PHONE (714) 647-5700

MUSZZ T.D

STEVEN GAFFNEY

YOST

THEATER

TENANT IMPROVEMENTS

307 N. Spurgeon Street

Santa Ana, California

APPROVED PLANS

The stamping of this set of plans SHALL NOT be held to permit or to approve the violation of any law, or structural stability of any building.


APPROVED 12-13-11

ARCHITECTURE INC

305 WEST FOURTH STREET SANTA ANA CA 92701

www.SGaffneyArch.com

TEL. 714.571.0500 **FAX**: 714.571.0600

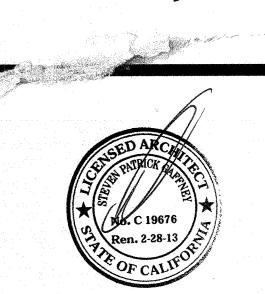


12-6-11


MEZZANINE PLATFORM REVISION

SHEET NUMBER

JOB NUMBER DATE

AS NOTED

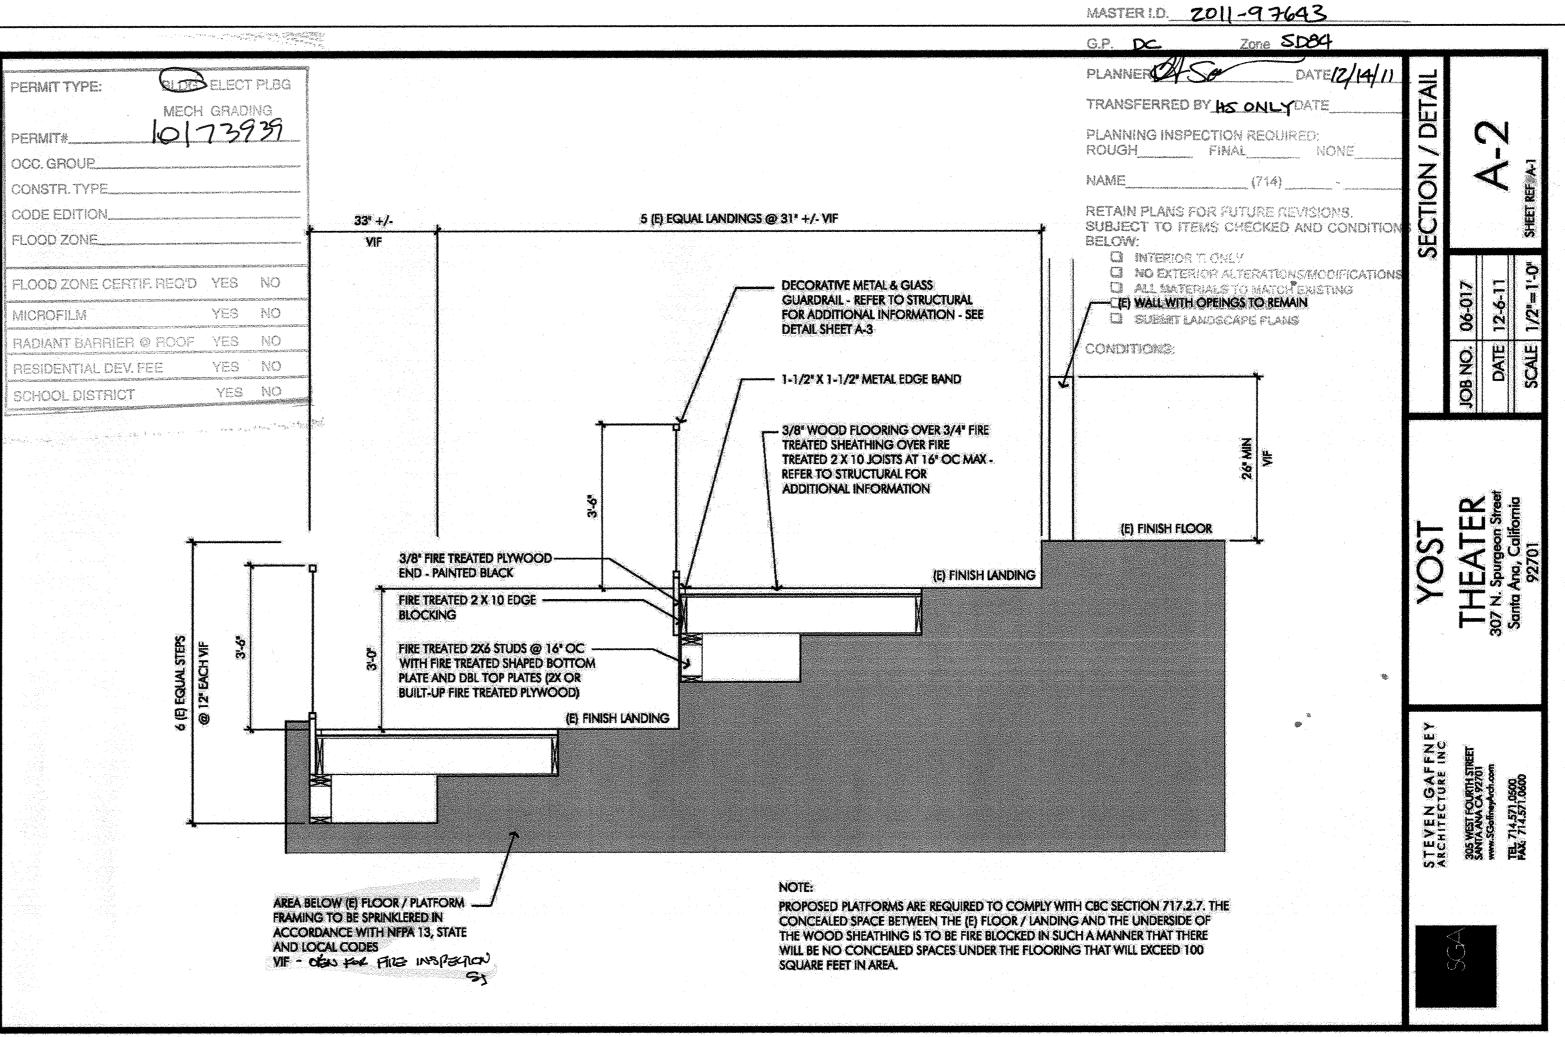


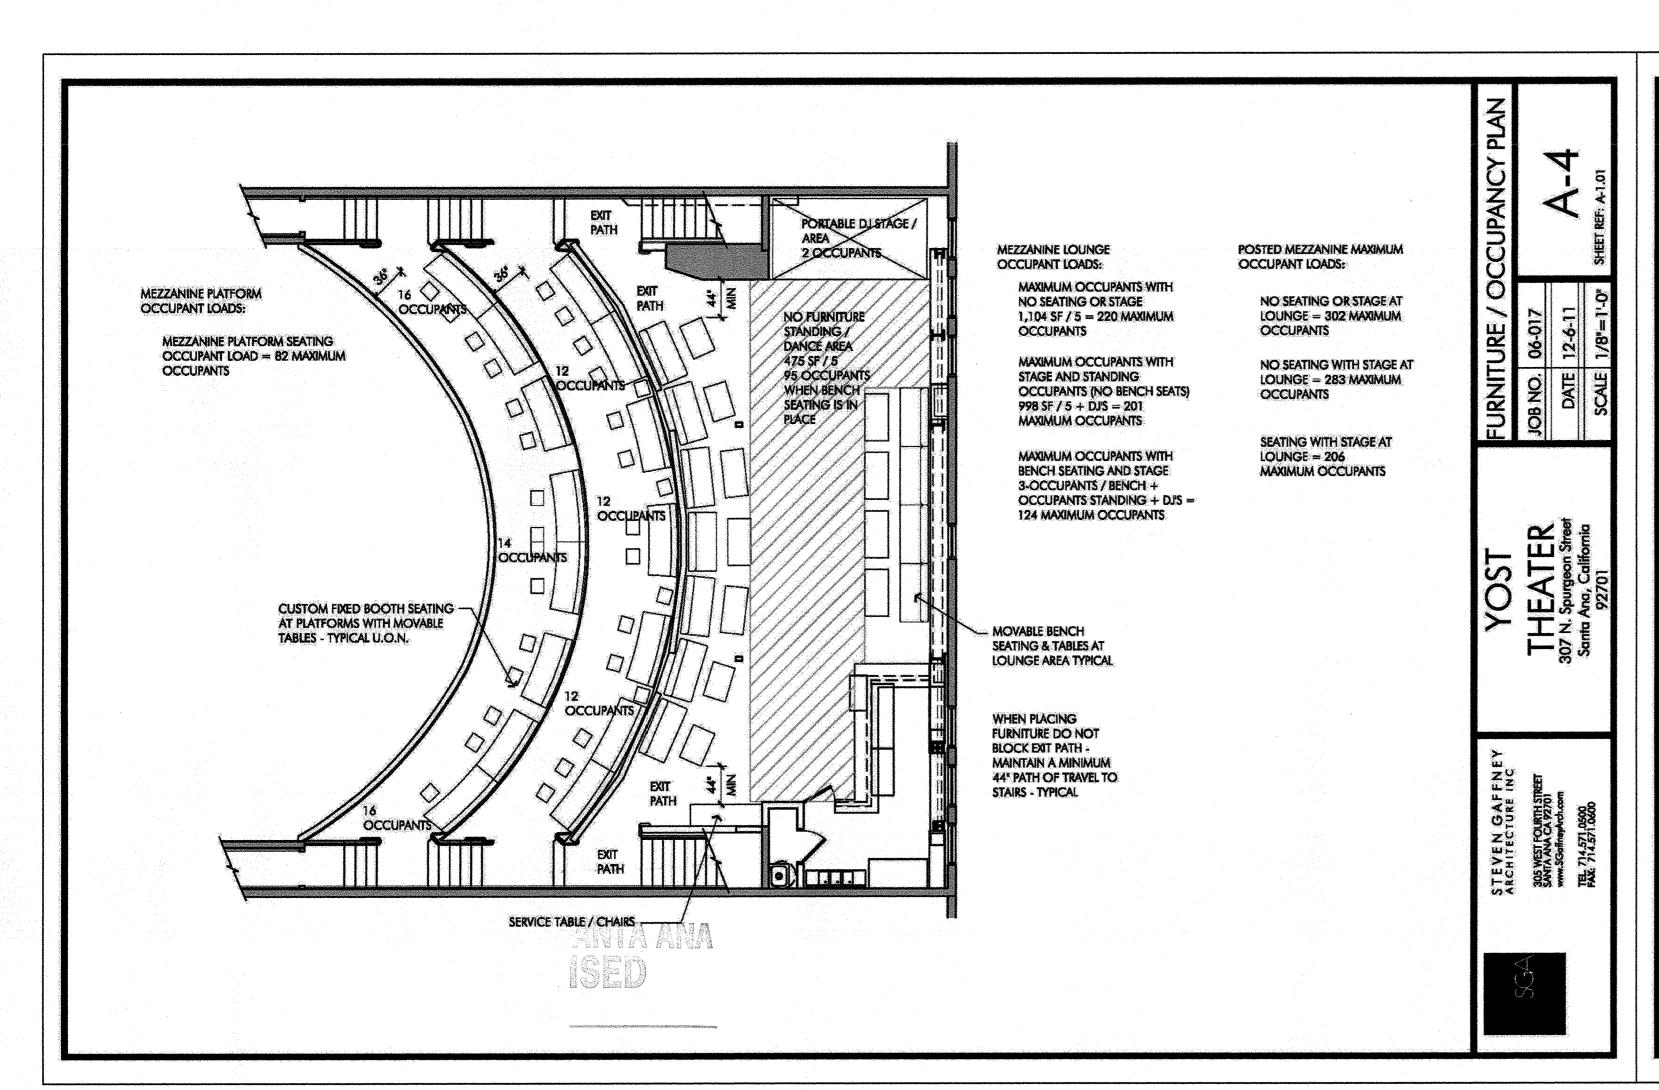


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DEC 14 2011

City of Santa Ana



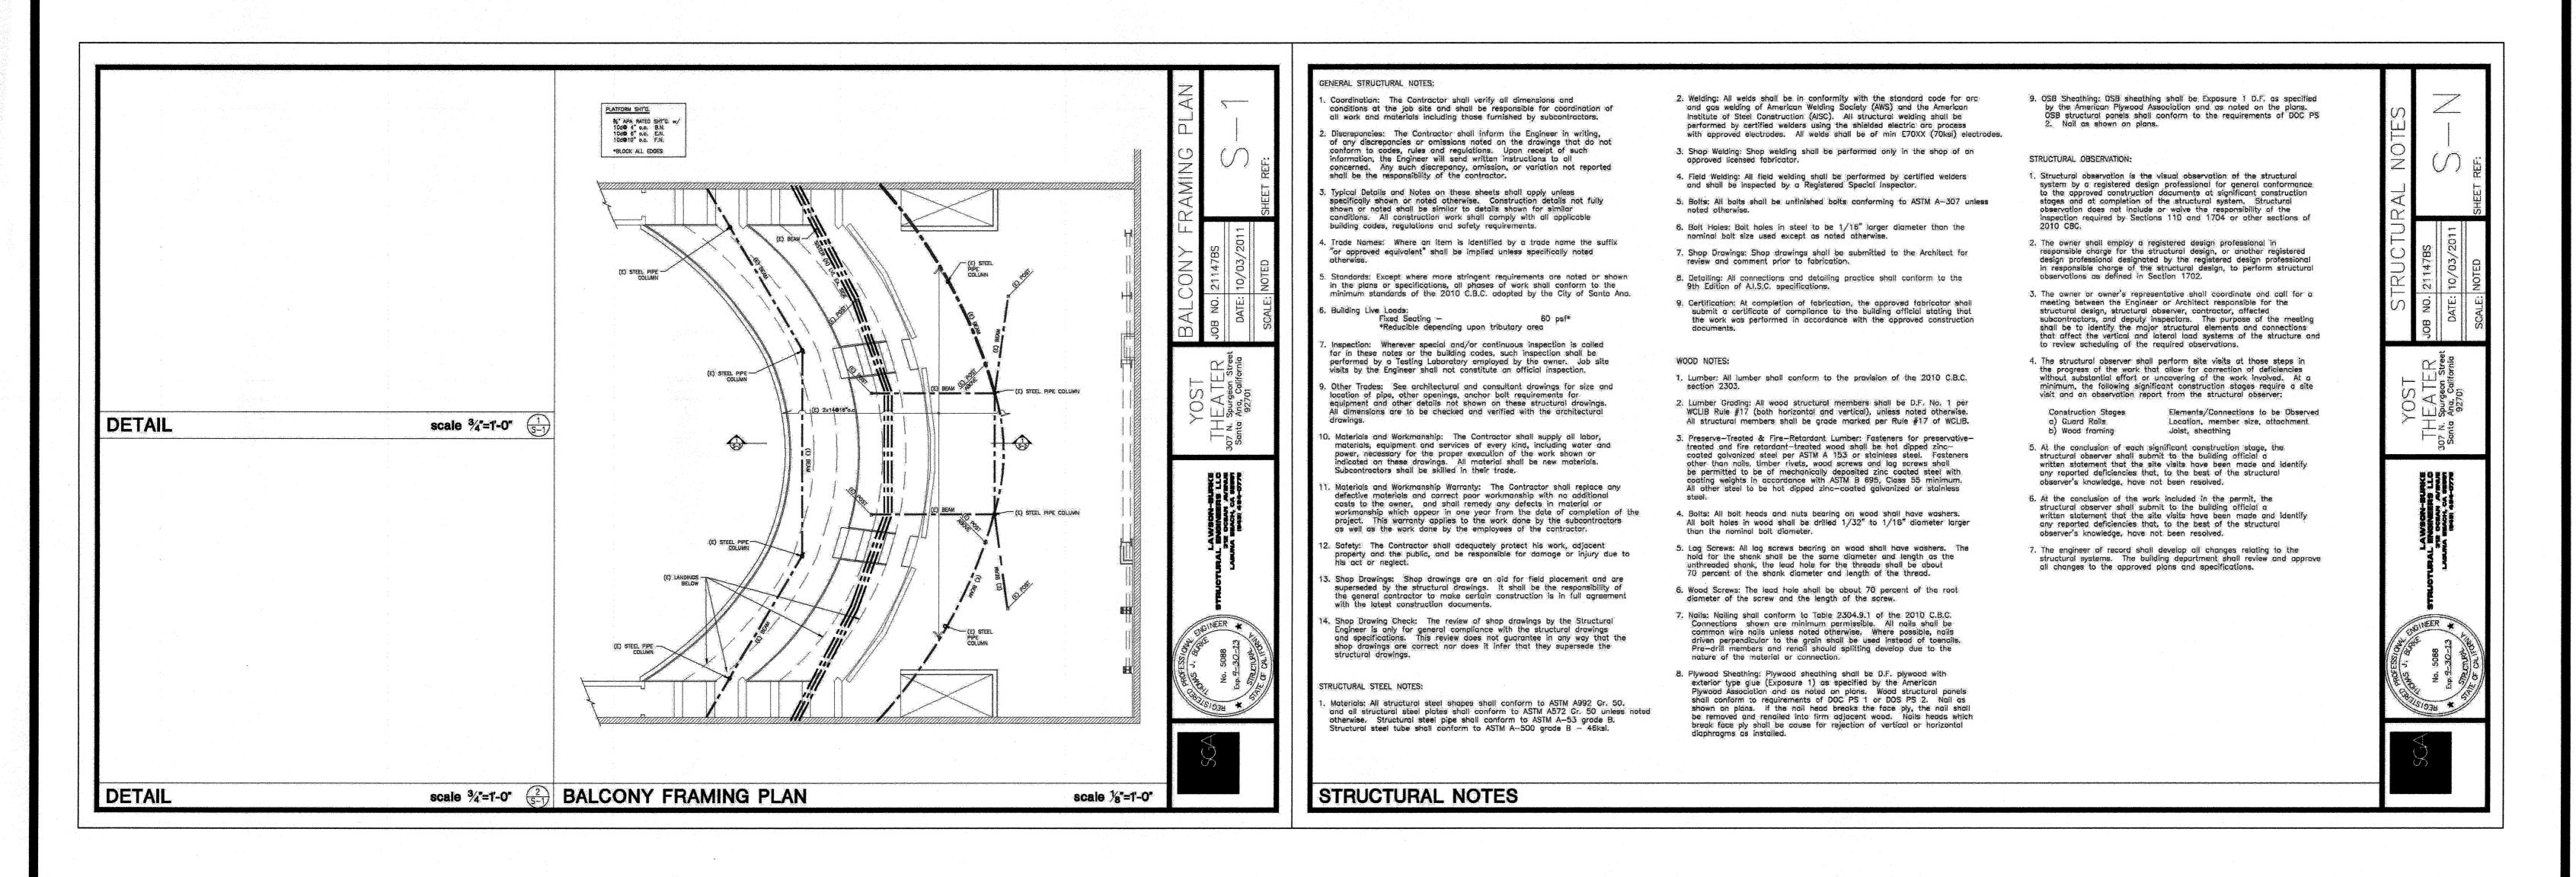
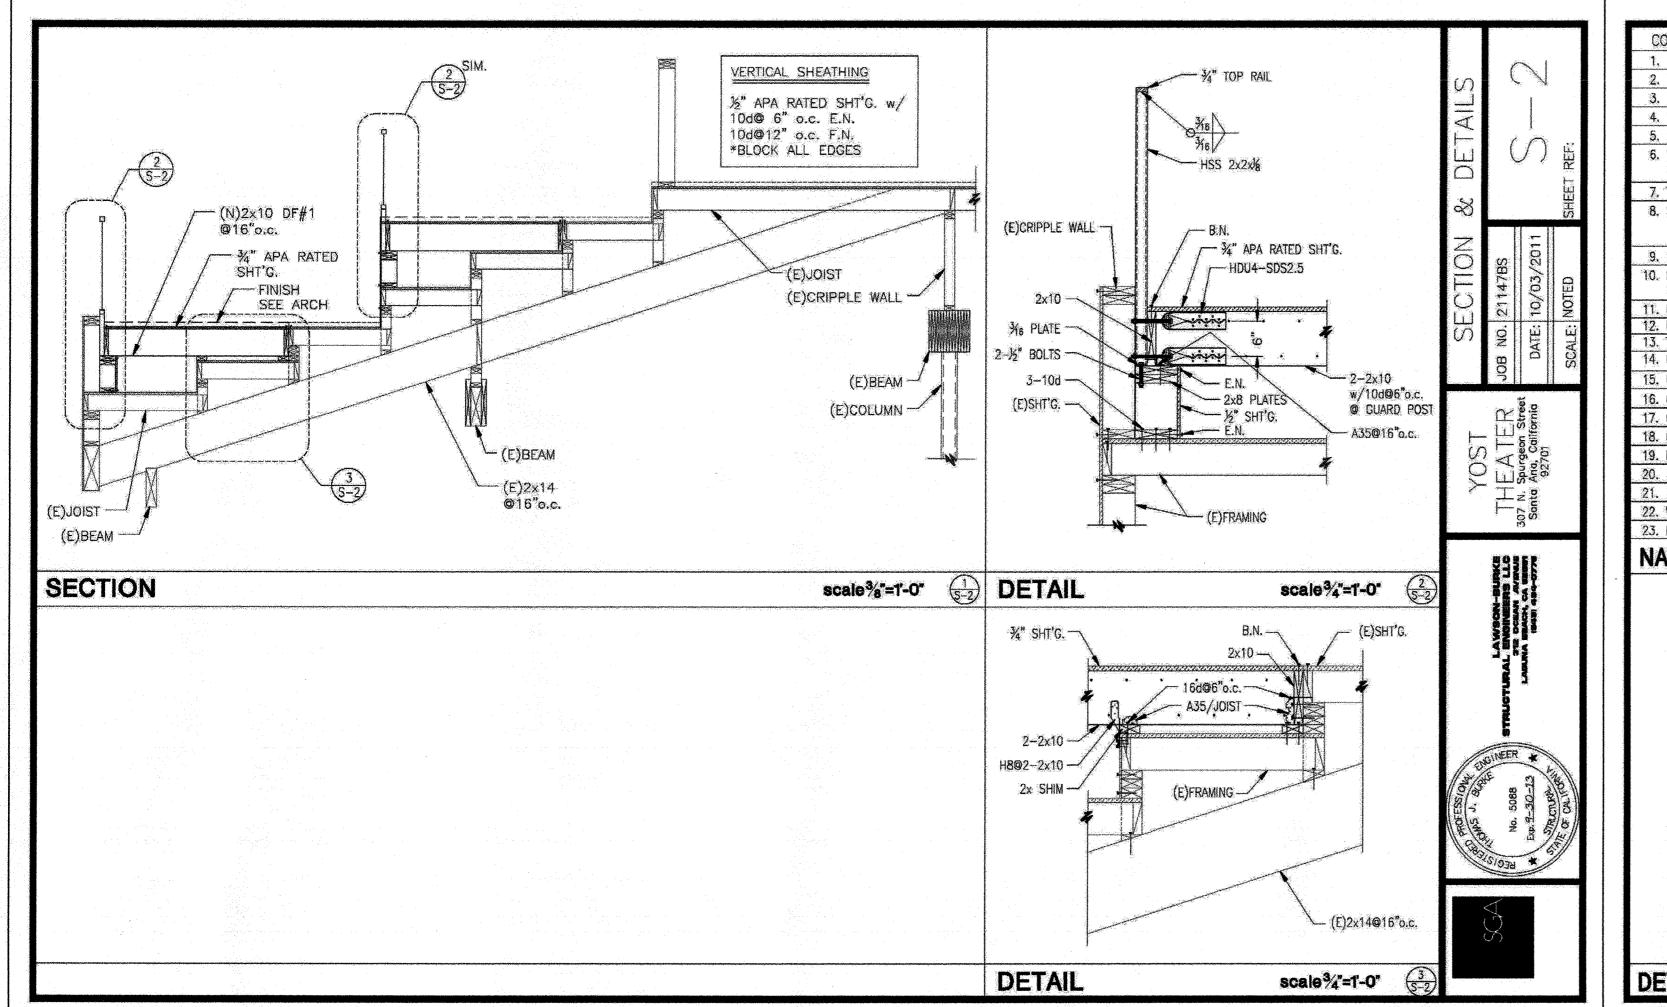
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STEVEN GAFFNEY ARCHITECTURE INC

305 WEST FOURTH STREET SANTA ANA CA 92701 www.SGaffneyArch.com

TEL. 714.571.0500 **FAX**: 714.571.0600

YOST THEATER

TENANT IMPROVEMENTS

307 N. Spurgeon Street Santa Ana, California

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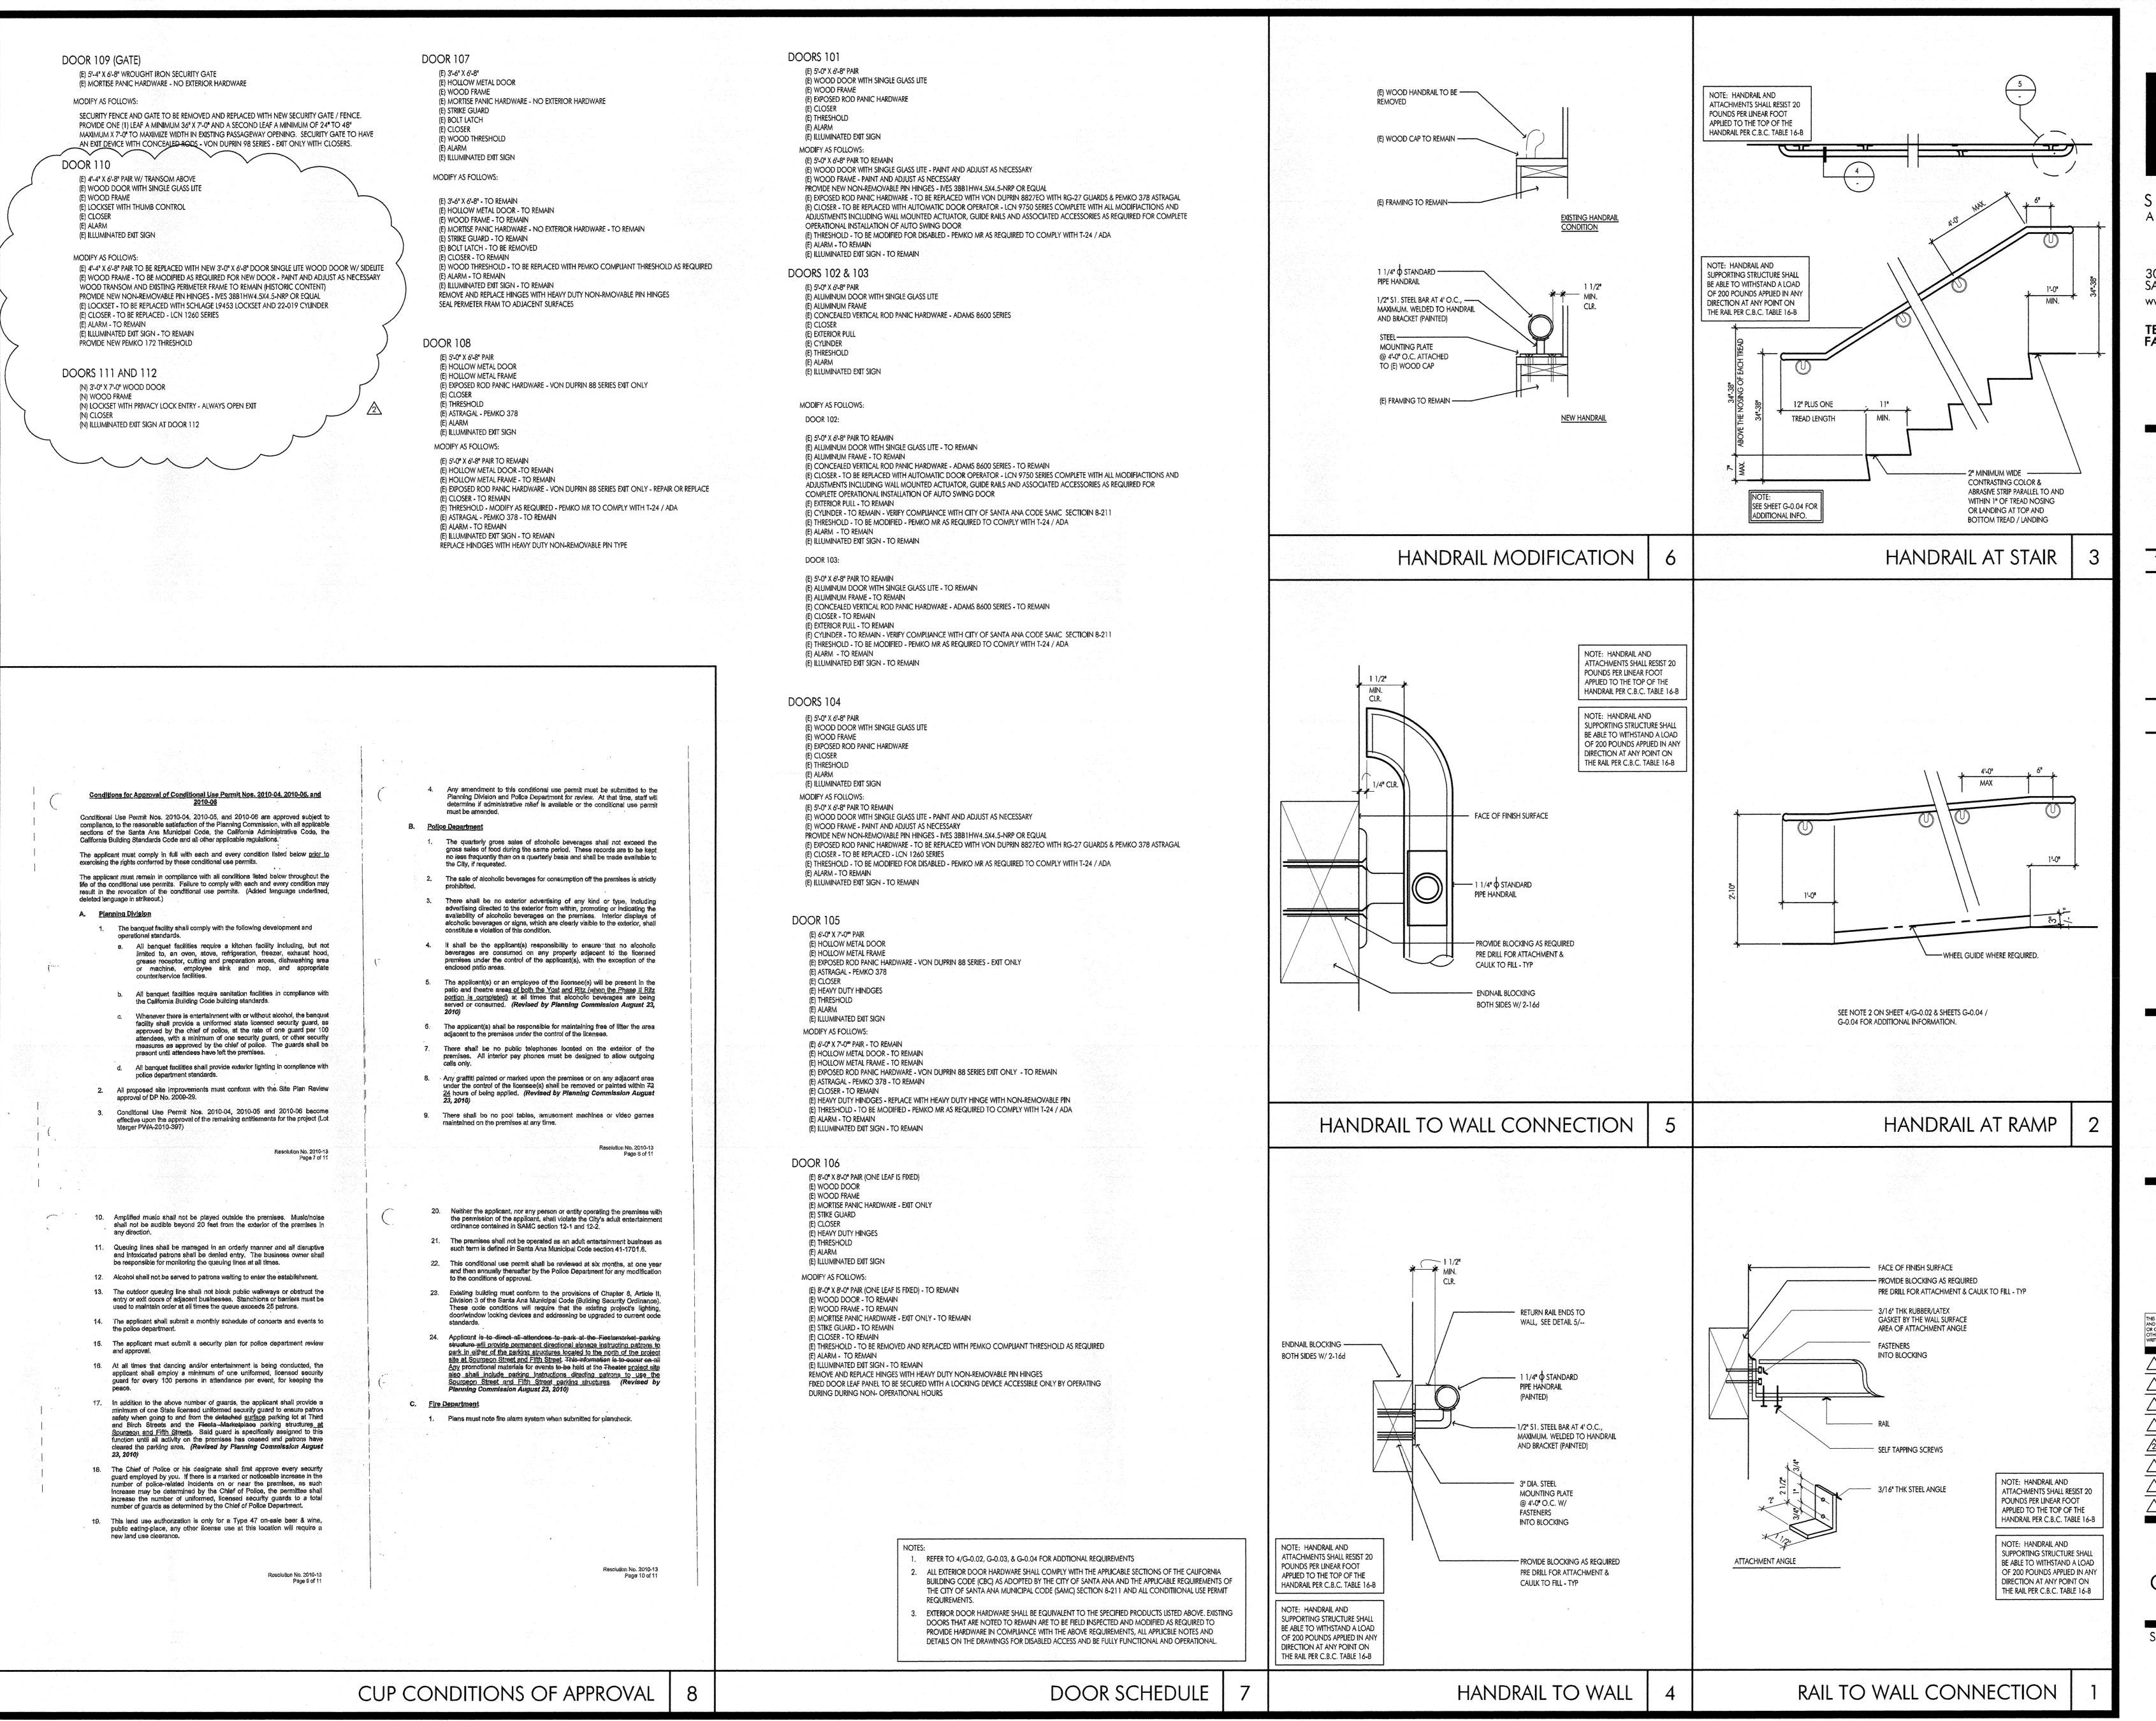
14-6-11

MEZZANINE PLATFORM REVISION

SHEET NUMBER JOB NUM

K-2

SCALE AS NOTED





STEVEN GAFFNEY ARCHITECTURE INC


305 WEST FOURTH STREET SANTA ANA CA 92701 www.SGaffneyArch.com

TEL. 714.571.0500 **FAX**: 714.571.0600

YOST **THEATER**

TENANT IMPROVEMENTS

307 N. Spurgeon Street Santa Ana, California

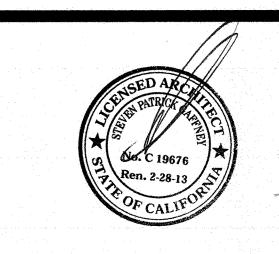

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DETAILS DOOR SCHED CUP CONDITIONS

JOB NUMBER SHEET NUMBER